# A PUBLIC HEARING AND REGULAR MEETING OF THE TOWN OF LADYSMITH COUNCIL AGENDA 5:30 P.M.

Tuesday, May 21, 2024 Ladysmith Seniors Centre 630 2nd Avenue

**Pages** 

# 1. CALL TO ORDER

Call to Order 5:30 p.m. in Open Session, in order to retire immediately into Closed Session.

Members of the public are welcome to attend all Open Meetings of Council, but may not attend Closed Meetings.

# 2. CLOSED SESSION

# Recommendation

That, in accordance with section 90(1) of the *Community Charter*, Council retire into closed session in order to consider items related to the following:

• (k) negotiations and related discussions respecting the proposed provision of a municipal service.

# 3. OPEN MEETING AND ACKNOWLEDGEMENT (6:00 P.M.)

The Town of Ladysmith acknowledges with gratitude that this meeting takes place on the unceded territory of the Stz'uminus First Nation.

Members of the public may attend meetings in person at the Ladysmith Seniors Centre or view the livestream on YouTube:

https://www.youtube.com/channel/UCH3qHAExLiW8YrSuJk5R3uA/featured.

#### AGENDA APPROVAL

#### Recommendation

That Council approve the agenda for this Public Hearing and Regular Meeting of Council for May 21, 2024.

# 5. PUBLIC HEARING

"Official Community Plan Bylaw 2003, No. 1488, Amendment Bylaw 2024, No. 2170" and "Town of Ladysmith Zoning Bylaw 2014, No. 1860, Amendment Bylaw 2024, No. 2171"

Subject Property: Lot A, Holland Creek

(Lot A Block 192 District Lot 103 Oyster District Plan EPP63594 Except Plan EPP67741, EPP75579, EPP80490, EPP98460 and EPP98461)

PID: 030-139-520

- 5.1 Outline of Public Hearing Process Mayor Stone
- 5.2 Introduction of Bylaws and Statutory Requirements Director of Development Services
- 5.3 Submissions
- 5.4 Call for Submissions to Council (Three Times) Mayor Stone
- 5.5 Declaration that the Public Hearing for Bylaw Nos. 2170 and 2171 is Closed Mayor Stone
- 6. BYLAWS OFFICIAL COMMUNITY PLAN AND ZONING (SUBJECTS OF THE PUBLIC HEARING)
  - 6.1 "Official Community Plan Bylaw 2003, No. 1488, Amendment Bylaw 2024, No. 2170"

### Recommendation

That Council give third reading to "Official Community Plan Bylaw 2003, No. 1488, Amendment Bylaw 2024, No. 2170".

6.2 "Town of Ladysmith Zoning Bylaw 2014, No. 1860, Amendment Bylaw 2024, No. 2171"

# Recommendation

That Council give third reading to "Town of Ladysmith Zoning Bylaw 2014, No. 1860, Amendment Bylaw 2024, No. 2171".

7. RISE AND REPORT- Items from Closed Session

10

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8.1	Minutes of the Regular Meeting of Council held May 7, 2024	16
	Recommendation That Council approve the minutes of the Regular Meeting of Council held May 7, 2024.	
8.2	Minutes of the Special Meeting of Council held May 14, 2024	25
	Recommendation That Council approve the minutes of the Special Meeting of Council held May 14, 2024.	
PRO	CLAMATIONS	
9.1	National AccessAbility Week - May 26 - June 1, 2024	27
	Mayor Stone has proclaimed May 26 - June 1, 2024 as "National AccessAbility Week" in the Town of Ladysmith.	
DEV	ELOPMENT APPLICATIONS	
10.1	Development Variance Permit 3090-24-02 and Development Permit 3060-22-14 – 670 Farrell Road	28
	Recommendation That Council:	
	<ol> <li>Issue Development Variance Permit 3090-24-02 to vary section 10.11.5 (a) of "Town of Ladysmith Zoning Bylaw 2014, No. 1860" to increase the maximum height of five proposed buildings from 10.0m to 16.8m at 670 Farrell Road (Lot 12, District Lot 41, Oyster District, Plan EPP119981; PID: 032-050- 844 as follows:</li> </ol>	
	<ul> <li>Building 4 to a maximum height of 11.0 metres;</li> </ul>	
	<ul> <li>Building 6 to a maximum height of 12.4 metres;</li> </ul>	
	<ul> <li>Building 7 to a maximum height of 11.5 metres;</li> </ul>	
	<ul> <li>Building 8 to a maximum height of 15.7 metres; and</li> </ul>	
	<ul> <li>Building 9 to a maximum height of 16.8 metres.</li> </ul>	
	<ol> <li>Issue Development Permit 3060-22-14 to allow construction of a 54-unit townhouse and multi-family development at 670 Farrell Road.</li> </ol>	

# 11. COMMITTEE MINUTES

# 11.1 Community Planning Advisory Committee - May 1, 2024

150

# Recommendation

That Council receive the minutes of the Community Planning Advisory Committee meeting held May 1, 2024.

# 11.2 Committee of the Whole - May 14, 2024

152

# Recommendation

That Council:

- 1. Give first, second and third readings to "Town of Ladysmith Animal Control Bylaw 2024, 2167"; and
- 2. Direct staff to bring forward consequential amendments to the "Town of Ladysmith Zoning Bylaw 2014, No. 1860".

# Recommendation

That Council direct staff to:

- 1. Amend "Town of Ladysmith Community Centre Facilities Fees and Charges Bylaw 2021, No. 2086," as presented in Attachment A of the May 14, 2024, staff report;
- Present the proposed FJCC admission changes to the Cowichan North Recreation Commission and Cowichan Valley Regional District for their respective endorsement;
- Upon the Commission's and Board's endorsement, bring the amended "Community Centre Facilities Fees and Charges Bylaw 2021, No. 2086" to Town of Ladysmith Council for consideration; and
- 4. Amend the "Fees and Charges Department: Parks, Recreation and Culture Policy" definition of family from four to six children.

# 12. BYLAWS

# 12.1 Bylaw Status Sheet

158

# 159

# 13.1 National Indigenous Peoples Day - Friday, June 21, 2024

# Recommendation

"That Council considers donating XXX to the Stz'uminus First Nation in support of their Indigenous People's Day 2024 event, with the funds to come from the Council public relations budget."

# 14. QUESTION PERIOD

- A maximum of 15 minutes is allotted for questions.
- Persons wishing to address Council during "Question Period" must be Town of Ladysmith residents, non-resident property owners, or operators of a business.
- Individuals must state their name and address for identification purposes.
- Questions put forth must be related to items on the agenda.
- Questions must be brief and to the point.
- Questions shall be addressed through the Chair and answers given likewise. Debates with or by individual Council members or staff members are not allowed.
- No commitments shall be made by the Chair in replying to a question.
   Matters which may require action of the Council shall be referred to a future meeting of the Council.

# 15. ADJOURNMENT

#### **TOWN OF LADYSMITH**

#### **BYLAW NO. 2170**

# A Bylaw to Amend "Official Community Plan Bylaw 2003, No. 1488"

The Council of the Town of Ladysmith in open meeting assembled enacts the following to effect changes to "Official Community Plan Bylaw 2003, No. 1488":

# **Definitions:**

1. For the purpose of this bylaw "subject property" means: Lot A Block 192 District Lot 103 Oyster District Plan EPP63594 Except Plan EPP67741, EPP75579, EPP80490, EPP98460 and EPP98461 (PID 030-139-520) and as shown in heavy black line in Schedules A, B, and C of this bylaw.

# **OCP Amendments:**


- 2. "Official Community Plan Bylaw 2003, No. 1488" is hereby amended as follows:
  - a. Map 1: Future Land Use is amended to reconfigure the land use designation for the subject property as shown in Schedule A;
  - b. Map 4: Parks and Facilities is amended to add the areas of the subject property shown in green in Schedule B to the 'Local Park' designation;
  - c. Map 8: Development Permit Areas is amended to add portions of the subject property to DPA 4: Multi-unit Residential, DPA 3: Commercial and DPA 10.

#### Citation


3. This Bylaw may be cited for all purposes as "Official Community Plan Bylaw 2003, No. 1488, Amendment Bylaw 2024, No. 2170".

<b>READ A FIRST TIME</b> on the 7 <sup>th</sup> da				
<b>READ A SECOND TIME</b> on the 7 <sup>th</sup>	day of May, 2024			
<b>PUBLIC HEARING HELD</b> Pursuar	nt to Section 464 o	f the Local Govern	ment Act on the	day
of, 2024				
<b>READ A THIRD TIME</b> on the	day of	, 2024		
ADOPTED on the	day of	, 2024		
			Mayor (	A. Stone)
			Corporate Officer (S	. Bouma)

# Schedule A

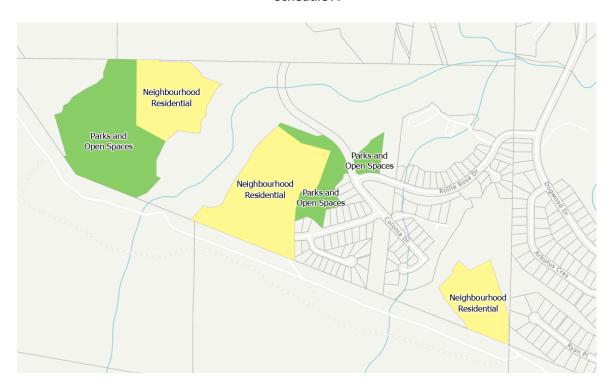

# Schedule B

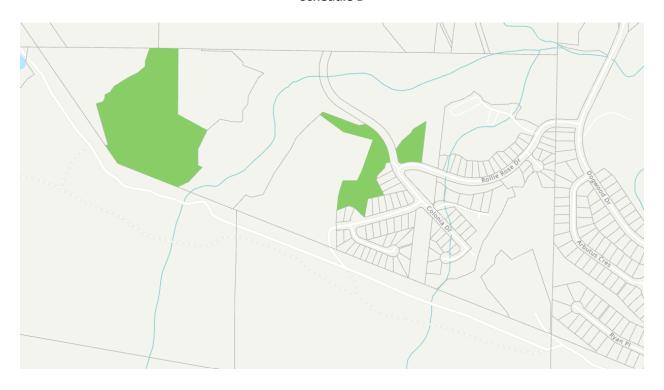

# Schedule C



#### **TOWN OF LADYSMITH**

#### **BYLAW NO. 2171**

# A Bylaw to amend "Town of Ladysmith Zoning Bylaw 2014, No. 1860"

The Council of the Town of Ladysmith in open meeting assembled enacts the following amendments to "Town of Ladysmith Zoning Bylaw 2014, No. 1860":

- 1. Schedule A Zoning Bylaw Text is amended by adding as section 17.8 the Holland Creek Mixed-Use Residential (CD-8) zone attached to this bylaw as Schedule A;
- 2. Schedule B is amended to rezone Lot A Block 192 District Lot 103 Oyster District Plan EPP 63594 Except Plan EPP67741, EPP75579, EPP80490, EPP98460, and EPP98461 to Comprehensive Development 8– Holland Creek Mixed-Use Residential (CD-8), Nature Park (P-3), Park and Recreation (P-2) and Low Density Residential (R-3-A) as shown in Schedule B of this bylaw;
- 3. Subsection 10.11(8)(d) is deleted and replaced with the following:
  - "d) For the areas shown as A, B and C in Figure 10.11.1:
    - i) Community Care Facility and Assisted Living Residence licensed under the Community Care and Assisted Living Act are permitted Principal Uses
    - ii) Coffee Shop, Office and Personal Service Establishment are permitted Accessory Uses to Community Care Facility and Assisted Living Residence";
- 4. Subsection 10.11(8)(e) is added as follows:
  - "e) Notwithstanding Section 10.11.4(b) and Section 10.11.5(d) for the area shown as area C in figure 10.11.1:
    - i) the maximum number of Dwelling Units permitted is 42 Dwelling Units per hectare of Land; and
    - j) The minimum setback from an Interior or Exterior Side Parcel Line shall be 2 meters"; and
- 5. Figure 10.11.1 is deleted and replaced with the following:



FIGURE 10.11.1: PLAN OF AREAS A, B, and C OF THE LOW DENSITY RESIDENTIAL (R-3-A) ZONE

# **Citation**

2. This Bylaw may be cited for all purposes as "Town of Ladysmith Zoning Bylaw 2014, No. 1860, Amendment Bylaw 2024, No. 2171".

READ A FIRS READ A SECO PUBLIC HEAD	OND T	<b>IME</b> or	n the 7 <sup>th</sup> day (	of Ma	y, 2024	ıl Govern	ment Act on the		day
of			, 2024						
<b>READ A THIR</b>	RD TIN	<b>1E</b> on t	he		day of,	2024			
APPROVED	BY	THE	MINISTRY	OF	TRANSPORTATION	AND	INFRASTRUCTURE	on	the
		day	of		, 2024				
						_ , 2024			
							Mayor	(A. S	tone)
							Corporate Officer (	(S. Bo	 uma)

#### **SCHEDULE A**

# 17.8 COMPREHENSIVE DEVELOPMENT 8- HOLLAND CREEK MIXED-USE RESIDENTIAL (CD-8)

The purpose of the Comprehensive Development 8 Zone is to accommodate mixed-use residential neighbourhoods with a range of housing options and densities and local commercial services.

# 1. Principal Uses

- a) Multiple Unit Dwelling
- b) Single Unit Dwelling
- c) Townhouse Dwelling
- d) Two Unit Dwelling

# 2. Accessory Uses

- a) Artist Studio
- b) Bakery
- c) Coach House subject to Part 6, Section 6.5
- d) Coffee Shop
- e) Community Care Facility
- f) Convenience Store
- *a)* Cottage Industry
- h) Home Based Business, subject to Part 6, Section 6.8.
- i) Office
- i) Personal Service Establishment
- k) Retail Sales
- I) Secondary Suite subject to Part 6, Section 6.4.

# 3. Sizing and Dimension of Parcels


- a) No Parcel for a Single Unit Dwelling Use shall be created which has a Parcel Area less than 372 square metres in area.
- b) No Parcel for a Two Unit Dwelling, Townhouse Dwelling or Multiple-Unit Dwelling Use shall be created which has a Parcel Area less than 780 square metres in area.
- c) No Parcel shall be created which has a Frontage of less than 12.19 metres.

# 4. Size and Density of the Use of Land, Buildings and Structures

- a) For a Single Unit Dwelling section 10.4.4. "Size and Density of the Use of Land, Buildings and Structures" of Section 10.4 "Single Dwelling Residential Small Lot B Zone (R-1-B)" shall apply.
- b) For a Two Unit Dwelling section 10.6.4. "Size and Density of the Use of Land, Buildings and Structures" of Section 10.6 "Old Town Residential (R-2)" shall apply.
- c) For a Multiple-Unit Dwelling or a Townhouse Dwelling the Floor Space Ratio shall not exceed 2.0.

- d) Notwithstanding subsections 17.8(4) (a), (b) and (c), the maximum number of *Dwelling Units* permitted in this zone shall not exceed:
  - i. 100 units in Area A as shown in Figure 17.8.1; and
  - ii. 400 units in Area B as shown in Figure 17.8.1

#### **FIGURE 17.8.1**

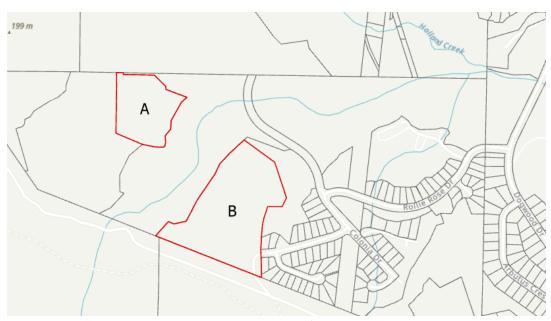

- e) The maximum Parcel Coverage of all Buildings and/or Structures, excluding *Buildings* or *Structures* used exclusively for off-street parking, shall be 50.0 percent.
- f) Where at least 50% of required off-street parking is provided underground, the maximum Parcel Coverage of all Buildings and/or Structures, excluding Buildings or Structures used exclusively for off-street parking, shall be 60.0 percent.
- g) No commercial use shall have a Gross Floor Area greater than 200 square metres.
- h) The combined Floor Space Ratio for all commercial uses on a Parcel shall not exceed 0.5.
- i) Commercial uses may only be located on the *First Storey* of a Building.
- j) A Parcel may contain more than one Principal Building.
- k) Despite subsection 17.8(4)(j) a parcel less than 780 square meters shall not contain more than one Principal Building

# 5. Siting, Sizing and Dimension of Uses Buildings and Structures

- a) No Multi-Family Building shall exceed a Height of 14 metres.
- b) No Single-Unit or Two-unit Building shall exceed a Height of 9.0 metres
- c) Despite subsection (b), where the roof pitch of a *Single-Unit or Two-unit* is less than 4:12, the maximum Height shall be 7.5 metres.
- d) No Accessory Building or Structure shall exceed a Height of 7.5 metres; except where the roof pitch is less than 4:12, in which case the maximum shall be 5.0 metres.
- e) No *Principal Buildings* or *Structures* shall be located closer to the *Parcel Line* than the minimum setback shown in the Table below:

Parcel Line	Minimum Setback		
Front Parcel Line	6.0 metres		
Interior Side of Parcel (Single-unit dwelling	2.0 Metres		
or Two-unit dwelling)			
Exterior Side of Parcel (Single-unit dwelling or	2.5 metres		
Two-unit dwelling)			
Exterior/Interior Side of Parcel (multiple-unit	4.5 metres		
dwelling)			
Rear Parcel Line	4.5 metres		

f) No Accessory Building or Structure shall be located closer to the Parcel Line than the minimum Setback shown in the Table below:

Parcel Line	Minimum Setback
Front Parcel Line	6.0 metres
Interior or Exterior Side Parcel Line	1.5 metre
Rear Parcel Line	1.5 metre

# 6. Landscaping and Screening

a) Landscaping and screening shall be provided in accordance with Part 7: Landscaping and Screening Regulations.

# 7. Parking and Loading

a) Off-street parking and off-street loading shall be provided in accordance with Part 8: Parking and Loading Regulations.

**Schedule B: Proposed Zoning** 





# MINUTES OF A REGULAR MEETING OF COUNCIL

Tuesday, May 7, 2024 6:31 P.M. Ladysmith Seniors Centre 630 2nd Avenue

**Council Members Present:** 

Mayor Aaron Stone Councillor Duck Paterson
Councillor Ray Gourlay Councillor Marsh Stevens
Councillor Amanda Jacobson Councillor Jeff Virtanen

Councillor Tricia McKay

**Staff Present:** 

Allison McCarrick Ryan Bouma
Erin Anderson Sue Bouma
Chris Barfoot Andrea Hainrich

Jake Belobaba

# 1. CALL TO ORDER

Mayor Stone called this Meeting of Council to order at 6:31 p.m., in order to retire immediately into Closed Session.

# 2. CLOSED SESSION

# CS 2024-081

That, in accordance with section 90(1) of the *Community Charter*, Council retire into closed session in order to consider items related to the following:

- (e) the acquisition, disposition or expropriation of land or improvements, if the council considers that disclosure could reasonably be expected to harm the interests of the municipality; and
- (k) negotiations and related discussions respecting the proposed provision of a municipal service that are at their preliminary stages and that, in the view of the council, could reasonably be expected to harm the interests of the municipality if they were held in public.

**Motion Carried** 

# 3. OPEN MEETING AND ACKNOWLEDGEMENT (7:00 P.M.)

Mayor Stone called this Regular Meeting of Council to order at 7:10 p.m., recognizing with gratitude that it was taking place on the unceded territory of the Stz'uminus First Nation.

Councillor Gourlay congratulated 14-year-old Ladysmith Orcas Swim Club member, Colton Gonzales, for qualifying to compete in the upcoming Olympic Trials in Toronto.

#### 4. AGENDA APPROVAL

#### CS 2024-082

That Council approve the agenda for this Regular Meeting of Council for May 7, 2024.

Motion Carried

# 5. RISE AND REPORT- Items from Closed Session

Council rose from Closed Session at 6:57 p.m. without report.

# 6. MINUTES

# 6.1 Minutes of the Regular Meeting of Council held April 16, 2024

#### CS 2024-083

That Council approve the minutes of the Regular Meeting of Council held April 16, 2024.

Motion Carried

# 7. DELEGATIONS

# 7.1 Nikki Toxopeus and Joanne Sales - Broombusters and Friends of Holland Creek Trail

Nikki Toxopeus of Broombusters and Friends of Holland Creek, and Joanne Sales of Broombusters discussed the ecological pressures in the Holland Creek area and requested continued support for their volunteers. They also asked Council to consider adopting a bylaw that would help control the spread of invasive species and advised that developing a Memorandum of Understanding with FortisBC and BC Hydro could help keep rights-of-way free of broom. They responded to Council's questions.

Mayor Stone thanked the group for their work and expressed Council's desire to find the best balance for all involved.

# 7.2 Ladysmith Secondary School Improv Team - Presentation to Council

Ladysmith Secondary School teacher, Bill Taylor, and students Caidence Burns and Isabel Barclay, members of the Ladysmith Secondary School Improv Team, thanked Council for the grant-in-aid which allowed them to take part in the Canadian Improv finals in Ottawa where they placed 6<sup>th</sup> overall.

Mayor Stone and Council thanked the team for their presentation and wished them continued success.

### 8. PROCLAMATIONS

# 8.1 National Public Works Week

Mayor Stone has proclaimed May 19-25, 2024 as "National Public Works Week" in the Town of Ladysmith.

# 9. RECESS

#### CS 2024-084

By unanimous consent Council recessed at 7:58 p.m. with the intention to reconvene in five minutes.

Motion Carried

Council reconvened at 8:03 p.m.

# 10. BYLAWS - OFFICAL COMMUNITY PLAN & ZONING

# 10.1 OCP and Zoning Amendment Lot A Holland Creek

# CS 2024-085

That Council:

- 1. Having considered s. 475 of the *Local Government Act*, and in particular the matters set out in subsections (2)(a) and (b), resolve that:
  - a. the Stz'uminus First Nation, and School District 68 are the only entities that are appropriate to consult in connection with

- "Official Community Plan Bylaw 2003, No. 1488, Amendment Bylaw 2024, No. 2170";
- b. consultation should be early but need not be ongoing;
- the consultation process described in the staff report to Council dated May 7, 2024 is sufficient in respect to the proposed Official Community Plan amendment; and
- d. staff be directed to refer "Official Community Plan Bylaw 2003, No. 1488, Amendment Bylaw 2023, No. 2170" to the Stz'uminus First Nation as set out in resolution 1 for consultation in the manner described in the May 7, 2024 staff report to Council;
- 2. Give first and second readings to "Official Community Plan Bylaw 2003, No. 1488, Amendment Bylaw 2024, No. 2170";
- 3. Consider "Official Community Plan Bylaw 2003, No. 1488, Amendment Bylaw 2024, No. 2170" in conjunction with the Town's Financial Plan, the Town's Liquid Waste Management Plan, and the Cowichan Valley Regional District Solid Waste Management Plan, pursuant to section 477(3) of the *Local Government Act*;
- Consider "Official Community Plan Bylaw 2003, No. 1488, Amendment Bylaw 2024, No. 2170" in conjunction with the Town's Housing Needs Report and the housing information on which the report is based, pursuant to section 473(2.1) of the *Local* Government Act:
- 5. Direct staff to refer "Official Community Plan Bylaw 2003, No. 1488, Amendment Bylaw 2024, No. 2170" to School District 68 pursuant to section 476 of the *Local Government Act*;
- 6. Give first and second readings to "Town of Ladysmith Zoning Bylaw 2014, No. 1860, Amendment Bylaw 2024, No. 2171";
- 7. Direct staff to refer "Town of Ladysmith Zoning Bylaw 2014, No. 1860, Amendment Bylaw 2024, No. 2171" to the Ministry of Transportation and Infrastructure, after third reading of the bylaw, pursuant to section 52 of the *Transportation Act*;
- 8. Require that, as a condition of approval of Bylaws 2170 and 2171 the applicant be required to secure the following conditions through a covenant and/or statutory right of way, as described in the May 7,

2024 report to Council, following third reading and prior to adoption of the bylaws:

- a. Dedication as parkland, at time of subdivision or development, of the areas to be zoned P-2 and P-3 under Bylaw 2170;
- b. Town access to future park areas prior to dedication for the purposes of invasive plant removal and habitat enhancement;
- c. Construction of a bus shelter meeting BC Transit's "E2" standard or similar at the existing northbound stop at the Holland Creek Ball Fields;
- d. Installation of the necessary electrical infrastructure for all required multi-family parking to be "EV charger Ready";
- e. A requirement for a minimum of 10% of dwelling units to meet the BC Building Code, Building Access Handbook;
- f. A prohibition on the use of fossil fuel as a primary heating source for buildings;
- g. Dedication and construction of a direct emergency vehicle access/egress and pedestrian trail from the "Centre Parcel" to Colonia Drive when the "Centre Parcel" is developed;
- h. A prohibition on planting non-native plants on the "Western Parcel";
- i. Wildfire protection measures on the "Western Parcel" and "Centre Parcel" as recommended in the report provided as Attachment H to the May 7, 2024 report to Council; and
- j. A prohibition on clearing between March 1 and August 31;
- 9. Direct that, as a condition of approval of Bylaws 2170 and 2171, that the following amendments be made to covenant CA6857592, as described in the May 7, 2024 report to Council, following third reading and prior to adoption of the bylaws:
  - Removing the requirement to construct the "South Crossing" over Heart Creek;
  - b. Amending the 'Local Site Triggers' and 'Neighborhood Cumulative Triggers' to:
    - Allow construction of up to 100 units on the "Eastern Parcel" provided the developer improves the existing emergency access route to Ryan Place;
    - ii. Allow construction of up to 200 units on the "Centre Parcel" provided the developer completes the design and costing of the Colonia Drive extension from the boundary of Lot A District Lot 110 Oyster District Plan VIP75849 to Thetis Drive

- and prohibiting more than 200 units on the "Centre Parcel" until the Colonia Drive extension is constructed to the boundary of Lot A, and
- iii. Adding a prohibition on the development of the "Western Parcel" until:
  - 1. Colonia Drive is fully constructed to connect Malone Road to Thetis Drive;
  - a dedicated multi-use trail and emergency access/egress route is constructed over the "Western Parcel" and adjacent parkland, connecting public road to the Water Treatment Plant access road; and
  - a pedestrian pathway and crossing over Heart Creek is constructed connecting the southern portions of the "Centre Parcel" and "Western Parcel";
- 10. Require that the legal instruments under resolutions 8 and 9 be prepared by the Town's solicitor at the cost of the applicant; and
- 11. Direct staff to proceed with scheduling and notification of a public hearing for Bylaws 2170 and 2171 pursuant to section 464(1) of the *Local Government Act*.

Motion Carried

# 11. REPORTS

11.1 Stocking Lake Supply Main Preliminary Design Consultant Award CS 2024-086

That Council authorize staff to sole source the Stocking Lake Supply Main preliminary design work to Koers & Associates Engineering Ltd.

Motion Carried

# 11.2 Reassignment of Approved Capital funds

#### CS 2024-087

That Council:

- 1. Cancel the following capital projects and transfer the budgeted funds to the pavement operations budget:
  - Single Area Traffic Study for \$49,000;
  - Radar Speed Signs for \$35,000; and
  - o Bollards on 1st Avenue for \$30,000.
- 2. Amend the 2024-2028 Financial Plan accordingly.

### CS 2024-088

**AMENDMENT** 

That Council amend item 1 of resolution CS 2024-087 to replace "cancel the following capital projects" with "refer the following capital projects to a future year's budget".

Amendment Carried

# Resolution CS 2024-087, as amended, reads:

That Council:

- 1. Refer the following capital projects to a future year's budget and transfer the budgeted funds to the pavement operations budget:
  - Single Area Traffic Study for \$49,000;
  - o Radar Speed Signs for \$35,000; and
  - o Bollards on 1st Avenue for \$30,000.
- 2. Amend the 2024-2028 Financial Plan accordingly.

Main Motion, as Amended, Carried

# 11.3 Mosaic Emergency Road Use Agreement Amendment

# CS 2024-089

That Council authorize the Corporate Officer to sign a Road Use Agreement Amendment with Mosaic Forest Management Corp. for the purposes of emergency access from 4<sup>th</sup> Avenue via the Ladysmith Main logging road. *Motion Carried* 

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# 11.4 Canoe Procurement Group Membership

### CS 2024-090

That Council:

- 1. Authorize staff to maintain membership with Canoe Procurement Group; and
- 2. Direct staff to consider and use Canoe for all applicable purchases. *Motion Carried*

# 12. BYLAWS

# 12.1 Bylaws for Adoption

# 12.1.1 "Property Tax Rates Bylaw 2024, No. 2175"

# CS 2024-091

That Council adopt "Property Tax Rates Bylaw 2024, No. 2175". *Motion Carried* 

# 12.1.2 "Sewer Parcel Tax Bylaw 2024, No. 2176"

# CS 2024-092

That Council adopt "Sewer Parcel Tax Bylaw 2024, No. 2176". *Motion Carried* 

# 12.1.3 "Water Parcel Tax Bylaw 2024, No. 2177"

# CS 2024-093

That Council adopt "Water Parcel Tax Bylaw 2024, No. 2177".

Motion Carried

# 12.2 Bylaw Status Sheet

# 13. CORRESPONDENCE

# 13.1 14th Annual Chamber of Commerce Charity Golf Tournament

#### CS 2024-094

That Council allocate \$250.00 to sponsor a hole at the 14<sup>th</sup> Annual Chamber of Commerce Charity Golf Tournament on June 14, 2024 as requested in the correspondence received April 23, 2024. *Motion Carried* 

# 13.2 Rocky Creek Ventures Inc. Subdivision and Street Naming Request

### CS 2024-095

That Council approve the request by Rocky Creek Ventures Inc., in their correspondence dated April 23, 2024, to name the 1301 Rocky Creek Road subdivision "Rocky Creek Estates" and the street, "Marina View Drive."

# CS 2024-096

**AMENDMENT** 

That Council amend resolution CS 2024-095 to remove approval of the subdivision name.

Amendment Carried

# Resolution CS 2024-095, as amended, reads:

That Council approve the request by Rocky Creek Ventures Inc., in their correspondence dated April 23, 2024, to name the 1301 Rocky Creek Road subdivision street "Marina View Drive."

Main Motion, as Amended, Carried

# 14. QUESTION PERIOD

A resident asked about the public hearing process in item 10.1 and requested clarification about the traffic study in item 11.1.

# 15. ADJOURNMENT

### CS 2024-097

That Council adjourn this Regular Meeting of Council at 9:06 p.m. *Motion Carried* 

6	CERTIFIED CORRECT
Mayor (A. Stone)	Corporate Officer (S. Bouma)



# MINUTES OF A SPECIAL MEETING OF COUNCIL

Tuesday, May 14, 2024 5:30 P.M. Ladysmith Seniors Centre 630 2nd Avenue

**Council Members Present:** 

Mayor Stone Councillor Paterson
Councillor Gourlay Councillor Stevens
Councillor Jacobson Councillor Virtanen

Councillor McKay

**Staff Present:** 

Allison McCarrick Chris Geiger
Erin Anderson Michele Gill
Chris Barfoot Sue Bouma
Jake Belobaba Andrea Hainrich

Ryan Bouma

# 1. CALL TO ORDER AND ACKNOWLEDGEMENT

Mayor Stone called this Special Meeting of Council to order at 5:30 p.m. and acknowledged with gratitude that it was being held on the unceded territory of the Stz'uminus First Nation.

# 2. AGENDA APPROVAL

# CS 2024 -098

That Council approve the agenda for this Special Meeting of Council for May 14, 2024.

**Motion Carried** 

# 3. REPORTS

# 3.1 Infrastructure Extension Request: Small Scale Multi-Unit Housing Bylaw Amendments

# CS 2024 -099

That Council direct staff to submit an application to the Minister of Housing seeking an extension until December 31, 2030, to implement the Province's Small Scale Multi-Unit Housing requirements pursuant to section 786 of the *Local Government Act*, for the areas described in the May 14, 2024, report to Council.

Motion Carried

# 3.2 Alternative Approval Process Confirmation – City Hall

#### CS 2024 -100

That Council:

- Confirm its direction to staff to carry out an Alternative Approval Process to obtain elector approval to build a new City Hall including Institutional/Commercial space below a housing development on Town-owned lands at 1<sup>st</sup> Avenue and Buller Street;
- 2. Establish the deadline for receiving elector responses as 4:00 p.m. on June 25, 2024 (33 days);
- 3. Establish that the elector response form will be the single elector response form;
- 4. Approve the total number of electors of the Town of Ladysmith to which the approval process applies is 741; and
- 5. Direct staff to report the results of the Alternative Approval Process to Council.

**Motion Carried** 

OPPOSED: Councillor Stevens

# 4. ADJOURNMENT

# CS 2024 -101

That this Special Meeting of Council be adjourned at 6:08 p.m.

Motion Carried	CERTIFIED CORRECT
Mayor (A. Stone)	Corporate Officer (S. Bouma)



# TOWN OF LADYSMITH

# **PROCLAMATION**

WHEREAS: National AccessAbility Week is a week for Canadians to promote

> inclusion and accessibility in our communities and workplaces, to celebrate our progress and to be inspired to further break down

accessibility barriers; and

**WHEREAS**: *Individuals with disabilities are impacted daily by barriers to* 

> information, facilities, employment, transportation and communication supports, therefore negatively challenging an individual's ability to fully

participate in community life; and

**WHEREAS**: Accessibility and inclusion are essential for ensuring that all community

members have equity in opportunities and the ability to fully participate

in community life.

THEREFORE, I, Aaron Stone, Mayor of the Town of Ladysmith, do hereby proclaim

May 26 – June 1, 2024 as "National AccessAbility Week" in the Town of

Ladysmith, British Columbia.

Mayor A. Stone

May 16, 2024

# STAFF REPORT TO COUNCIL

**Report Prepared By:** Andrew Wilson, Planner

**Reviewed By:** Jake Belobaba, RPP, MCIP, Director of Development Services

**Meeting Date:** May 21, 2024

File No: 3090-24-02 and 3060-22-14

RE: **Development Variance Permit 3090-24-02 and Development** 

Permit 3060-22-14 – 670 Farrell Road

# **RECOMMENDATION:**

That Council:

- 1. Issue Development Variance Permit 3090-24-02 to vary section 10.11.5 (a) of "Town of Ladysmith Zoning Bylaw 2014, No. 1860" to increase the maximum height of five proposed buildings from 10.0m to 16.8m at 670 Farrell Road (Lot 12, District Lot 41, Oyster District, Plan EPP119981; PID: 032-050-844 as follows:
  - Building 4 to a maximum height of 11.0 metres;
  - Building 6 to a maximum height of 12.4 metres;
  - Building 7 to a maximum height of 11.5 metres;
  - Building 8 to a maximum height of 15.7 metres; and
  - Building 9 to a maximum height of 16.8 metres.
- 2. Issue Development Permit 3060-22-14 to allow construction of a 54-unit townhouse and multi-family development at 670 Farrell Road.

# **EXECUTIVE SUMMARY:**

The purpose of this report is to introduce a proposal to construct 54 residential units at 670 Farrell Road consisting of three four-unit townhouse dwellings, four three-unit townhouse dwellings, and two four-storey, fifteen-unit apartment buildings for Council consideration. The proposed development requires a development variance permit and development permit.

The applicant is requesting a variance to increase the height of three of the townhouse buildings from 10 metres to 12.4 metres and two multi-unit buildings from 10.0 metres to 16.8 metres.

Staff recommend approval of DVP 3090-24-02 (Attachment B) based on analysis of the impacts. Staff recommend approval of DP 3060-22-14 (Attachment C) based on consistency with the Multi-Unit Residential - Development Permit Area 4 and Hazard Lands - Development Permit Area 7 guidelines.



# PREVIOUS COUNCIL DIRECTION:

N/A

# **INTRODUCTION/BACKGROUND:**

# Subject property

The subject property is a 14,568.7 square metre (1.46 ha.) parcel located at 670 Farrell Road. The property is currently designated Multi-Family Residential under the "Official Community Plan Bylaw 2022, No. 2200" (OCP), zoned R-3-A under the "Town of Ladysmith Zoning Bylaw 2014, No. 1860" and falls within the Multi-Unit Residential (DPA 4) and Hazard Lands (DPA 7) development permit areas. The property is an undeveloped greenfield site with second growth forest and rocky outcrops. The land slopes approximately 23m upward from Farell Road south to Stringer Way. Adjacent land uses include: the Trans-Canada Highway on the north side, an undeveloped forested property designated as Urban Reserve on the east side, a multi-family development on the west side, and a new suburban development on the south side which was recently subdivided from the subject property.

Three townhouse buildings are accessed from the eastern end of Farrell Road. Four townhouse buildings and two multi-unit apartment buildings are accessed from Stringer Way to the south. As part of the conditions for subdivision, the applicant(s) constructed an emergency access connecting Stringer Way with Farrell Road.

A map of the subject property is provided in Attachment A, conceptual renderings are provided in Attachment D, and Site Sections are provided in Attachment E.

# **PROPOSAL:**

The applicant proposes to construct a total of 54 residential units - three four-unit townhouse dwellings, four three-unit townhouse dwellings, and two four-storey fifteen-unit apartment buildings. Details of the site plan and building design are provided in Attachments B and D. The application includes height variances to five of the nine principal buildings These variances are summarized below.

A summary of the proposed variance is provided in Table 1, below.

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Zoning Regulation	Permitted Height	Building No.	No. of Units	No. of Storeys	Propose d Height	Variance Required	Proposed Variance
Principal	Maximum	Building	4	3 storeys +	9.38m	No	n/a
building	10.0m	1		rooftop patio			
height of R-				access			
3-A Zone		Building	4	3 storeys +	9.71m	No	n/a
		2		rooftop patio			
				access			

Building 3	4	3 storeys + rooftop patio access	9.74m	No	n/a
Building 4	3	3 storeys + rooftop patio access	10.56m	Yes	11.0m
Building 5	3	3 storeys + rooftop patio access	9.75m	No	n/a
Building 6	3	3 storeys + rooftop patio access	12.01m	Yes	12.4m
Building 7	4	3 storeys + rooftop patio access	11.11m	Yes	11.5m
Building 8	15	4 storeys + under-ground parking	15.17m	Yes	15.7m
Building 9	15	4 storeys + under-ground parking	16.29m	Yes	16.8m

If approved, DVP 24-02 will vary the maximum height for a principal building from 10m to 16.8m for the subject property and as specified on the Permit as follows:

- Building 4 to a maximum height of 11.0 metres;
- Building 6 to a maximum height of 12.4 metres;
- Building 7 to a maximum height of 11.5 metres;
- Building 8 to a maximum height of 15.7 metres; and
- Building 9 to a maximum height of 16.8 metres.

The proposed development complies with all other regulations of the R-3-A zone.

In accordance with the OCP, a DP is required prior to construction as the property is also located within Development Permit Area 4 (DPA 4) – Multi-Unit Residential and DPA 7 – Hazard Lands.

A letter of rationale from the applicant is provided as Attachment F.

#### **ANALYSIS:**

For the reasons outlined below, staff recommend the proposal be approved.

# Official Community Plan

The subject property is located in the Multi-Family land use designation in the OCP. Multi-family areas provide for greater diversity and density of multi-family residential types and tenures. Taller buildings of up to six storeys are supported by this designation. The proposed multi-family development is consistent with the OCP designation. The property is also located

within DPA 4 – Multi-Unit Residential and DPA 7 – Hazard Lands under the OCP, which therefore requires a DP.

The following OCP policies are relevant to the proposal:

Policy 2.3 Land Use Designation Policies:

- u. The built form of this designation should be buildings up to six storeys, with upper storeys stepped back.
- v. Minimum FSR should be 1.0. Maximum FSR should be 2.2.

# Policy 2.4 General Land Use Policies:

- a. Avoid urban spawl, which is the low-density, predominantly single-use expansion of urban areas that are disconnected from core growth areas and are typically on greenfield sites.
- u. Encourage underground parking for major developments.

# Zoning Bylaw

The subject property is zoned R-3-A in the Zoning Bylaw. The R-3-A zone permits a maximum building height of 10.0m. Five of the proposed buildings range from 10.56m (Building 4) to 16.29m (Building 9) tall, therefore a variance is required. The proposal meets all other Zoning Bylaw regulations.

# Variance Proposal

The applicant is requesting to vary the height of three townhouse buildings from 10.0m to 12.4m and the two multi-unit buildings from 10.0m to 16.8m. The increase in height is to accommodate the site topography, minimize site impact, and increase overall density of the project.

Townhouse buildings 4, 6, and 7 are located in the mid-slope development phases 3 and 4. This area has steeper slope conditions than all other areas on the parcel. Townhouses are designed with three storeys including a half lower storey for the garages. The proposed rooftop patio staircase access accounts for 2.7m of the additional height for each townhouse building. Four of seven townhouse buildings comply with the maximum height regulations and do not require a variance. The proposed location of these buildings does not impact views of other units.

The proposed variances for apartment buildings 8 and 9 are to facilitate a fourth storey for increased units and underground parking for each building. The proposed elevation of the two buildings is approximately 13.3m above grade at the cul-de-sac at the end of Stringer Way.

Staff recommend that the variance be approved since the height increase aligns with OCP policies, including encouraging buildings of up to six stories, and will facilitate the following:

- provides less site impact given the challenging topography and geology;
- allows for more residential units in the multi-family buildings and in the overall proposal;
- accommodates underground parking in both apartment Buildings 8 and 9; and

 provides more private outdoor amenity space for the townhouse buildings including vertical and rooftop gardening potential.

Based on the analysis, staff do not expect negative impacts from the proposed variance, and therefore, recommend approval of DVP 24-02.

# Development Permit Guidelines

The proposal is subject to the requirements of DPA 4 – Multi-Unit Residential and DPA 7 – Hazard Lands. The purpose of DPA 4 is to achieve a high level of design for multi-unit development, to enhance the Town's neighbourhood, and to ensure that development is complementary to the existing character of Ladysmith.

The purpose of DPA 7 is to prevent land slippage and sloughing, safeguard private property from potential damage, minimize disruption to slope stability, and prohibit development from occurring in areas where slope instability hazards exist.

Attachment G provides a detailed review of the proposal in the context of the DPA 4 and DPA 7 guidelines. Highlights of the proposal include:

- Design featuring neo-traditional contemporary elements;
- Wood-look light grey hardiplank siding and red brick veneer on the apartment buildings;
- Three townhome design schemes for the exterior finishes providing a variation of colours of board and batten hardie panel, longboard wood-look aluminum siding, cultured stone cladding around the garage doors, and Douglas fir timber accents;
- Underground parking for the apartment units;
- Shared amenity spaces, including play equipment, fitness equipment, and resting viewpoint areas;
- A pedestrian connection through the development connecting buildings with the surrounding street network;
- Landscape plan, prepared by a landscape architect, featuring native and drought tolerant plants and high-efficiency irrigation;
- Bike storage and outdoor bicycle parking;
- 6 EV charging stations;
- A Geotechnical Assessment stating the development is considered safe as proposed, provided recommendations are followed; and
- Recommendations for safe construction and development best practices as described in the Geotechnical Assessment report and Erosion and Sediment Control Plan, attached to the development permit as Schedules H and J.

Staff recommend that the DP be issued since the proposal is generally consistent with the DPA 4 and DPA 7 guidelines. The permit contains a requirement for security to ensure that landscaping requirements are followed.

# **ALTERNATIVES:**

Council can choose to:

- 1. Not issue DVP 3090-24-02 and refer DP 3060-22-14 back to staff.
- 2. Not issue DP 3060-22-14 and specify the reasons for refusal citing specific development permit guidelines.
- 3. Defer consideration of the application and refer the proposal to a subsequent meeting of Council.
- 4. Amend the conditions of the proposed permits and approve the issuance of the permits as amended.
- 5. Refer the application back to staff for further review, as specified by Council.

# **FINANCIAL IMPLICATIONS:**

N/A

# **LEGAL IMPLICATIONS:**

Standard requirements for Council consideration and referrals under provincial legislation have been accounted for in staff's review and processing of the application and in the recommendations of this report.

The Local Government Act allows Council to vary Zoning Bylaw regulations (excluding regulations for use, density and rental tenure) through issuance of a DVP. Development Variance Permits are discretionary decisions of Council, and Council has no obligation to approve the proposed variance. If the proposed variance is denied, the proposed Development Permit must either be approved as amended (see Alternative 4) or denied. If only the Development Permit is refused, reasons must be given based on the DPA 4 or DPA 7 Guidelines as the issuance of a DP is not a completely discretionary decision of Council.

# **CITIZEN/PUBLIC RELATIONS IMPLICATIONS:**

Mail notification for the proposed development variance permit pursuant to section 499 of the *Local Government Act,* was carried out on May 10, 2024. The notice was mailed and delivered to property owners/residents within 60m of the subject property. No written submissions were received prior to the time of writing.

# **INTERGOVERNMENTAL REFERRALS:**

N/A

# **INTERDEPARTMENTAL INVOLVEMENT/IMPLICATIONS:**

The application was circulated amongst Town departments for review. Their comments are summarized below:

Table 2: Department Comments

Referred	Department	Comments
(Yes/No)		

Yes	Infrastructure Services	The applicant amended design plans and provided additional information in response
		to all Engineering concerns.
Yes	Building Inspection	Buildings were sited to comply with all BC
		Building Code and Town requirements.
		Additional changes can be addressed during
		the Building Permit stage.
No	Parks Recreation and Culture	N/A
No	Financial Services	N/A
No	Legislative Services/Corporate Services	N/A
Yes	Fire/Protective Services	Concerns of fire access turning lanes,
		slopes, and fire access distances were all
		reviewed. Site plans were amended to meet
		Town requirements.

# **COMMUNITY PLANNING ADVISORY COMMITTEE (CPAC) REVIEW:**

Under CPAC Terms of Reference a CPAC review of this application is not required.

□ Core Infrastructure	☐ Economy
$\square$ Official Community Plan Implementation	☐ Leadership
☐ Waterfront Area Plan	


I approve the report and recommendation(s).

Allison McCarrick, Chief Administrative Officer

# **ATTACHMENTS:**

- A. Subject Property Map
- B. Draft DVP 3090-24-02
- C. Draft DP 3060-22-14
- D. Conceptual Renderings
- E. Site Sections
- F. Applicant Letter of Rationale
- G. Review of DPA Guidelines

# ATTACHMENT A

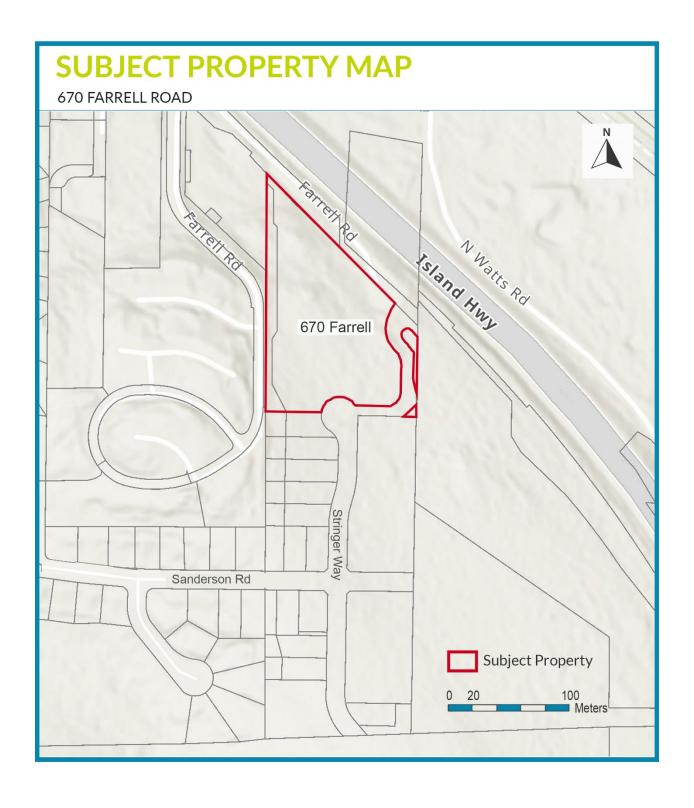



# TOWN OF LADYSMITH DEVELOPMENT VARIANCE PERMIT

(Section 498 Local Government Act)

FILE NO: 3090-24-02

DATE: May 21, 2024

Name of Owner(s) of Land (Permittee): Arkell Apartments Ltd., Inc. No. BC1453834

Applicant: Adam Kelln, Robyn Kelln, Gustavo Da Roza (G3 Architecture Inc.)

Subject Property (Civic Address): 670 Farrell Road

- 1. This Development Variance Permit is issued subject to compliance with all of the bylaws of the Town of Ladysmith applicable thereto, except as specifically varied or supplemented by this Permit.
- 2. This Development Variance Permit applies to and only to those lands within the Town of Ladysmith described below and any and all buildings, structures, and other development thereon:


Lot 12, District Lot 41 Oyster District Plan EPP119981 PID: 032-050-844 (670 Farrell Road) (referred to as the "Land)


- 3. Section 10.11.5 a) of the "Low Density Residential (R-3-A)" zone of the "Town of Ladysmith Zoning Bylaw 2014, No. 1860", as amended, is varied for the Land by increasing the Height of a Principal Building from 10.0 metres to 16.8 metres to allow for the construction of three Townhouse Dwellings and two Multiple-Unit Dwellings as shown in Schedule A - Site Plan and Schedule B - Elevation Plans and as follows:
  - Building 4 to a maximum height of 11.0 metres;
  - Building 6 to a maximum height of 12.4 metres;
  - Building 7 to a maximum height of 11.5 metres;
  - Building 8 to a maximum height of 15.7 metres; and
  - Building 9 to a maximum height of 16.8 metres.
- 4. The land described herein shall be developed strictly in accordance with terms and conditions and provisions of this Permit and any plans and specifications attached to this Permit which shall form a part thereof.


Page 1 of 2

- 5. Notice of this Permit shall be filed in the Land Title Office at Victoria under s.503 of the *Local Government Act*, and upon such filing, the terms of this Permit (3090-24-02) or any amendment hereto shall be binding upon all persons who acquire an interest in the land affected by this Permit.
- THIS PERMIT IS NOT A BUILDING PERMIT. No occupancy permit shall be issued until all items of this Development Variance Permit have been complied with to the satisfaction of the Corporate Officer.

AUTHORIZED BY RESOLUTION NO	PASSED BY THE COUNCIL OF THE
TOWN OF LADYSMITH ON THE DAY	OF202
	Mayor (A. Stone)
	Corporate Officer (S. Bouma)

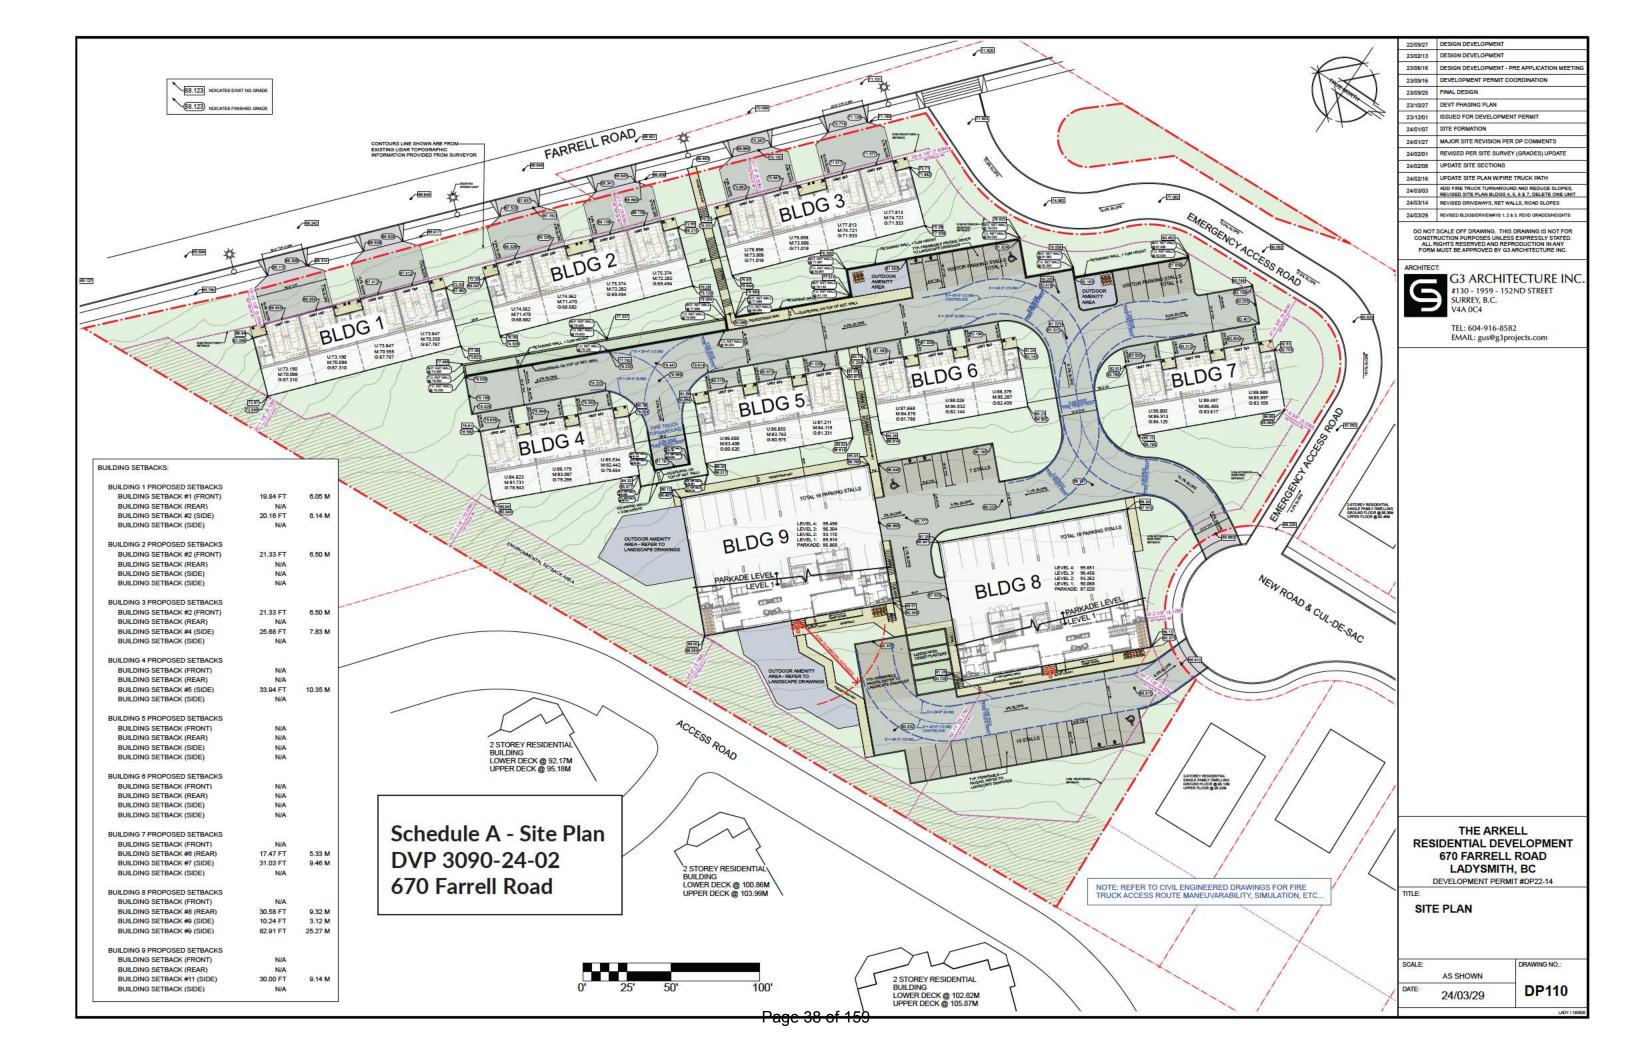

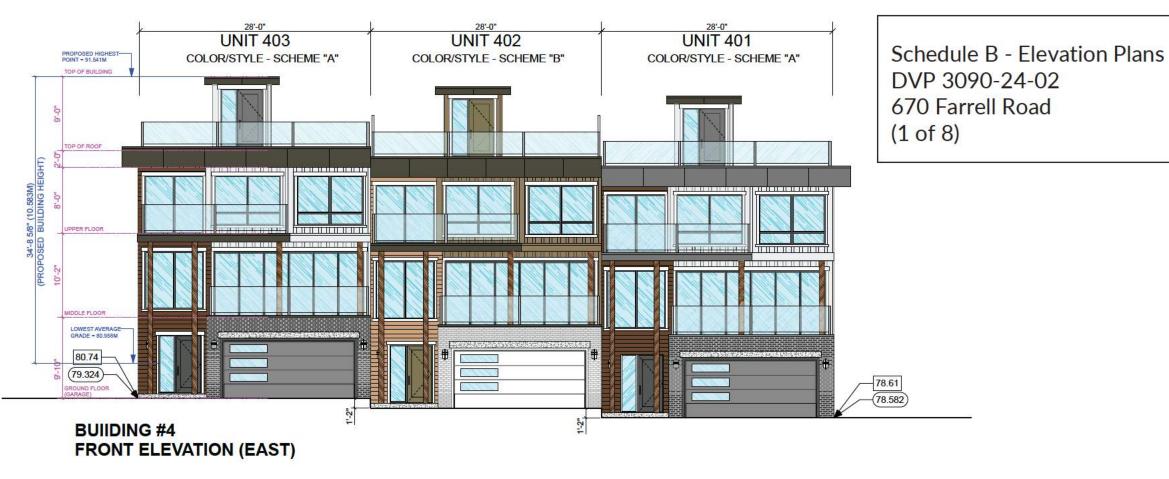

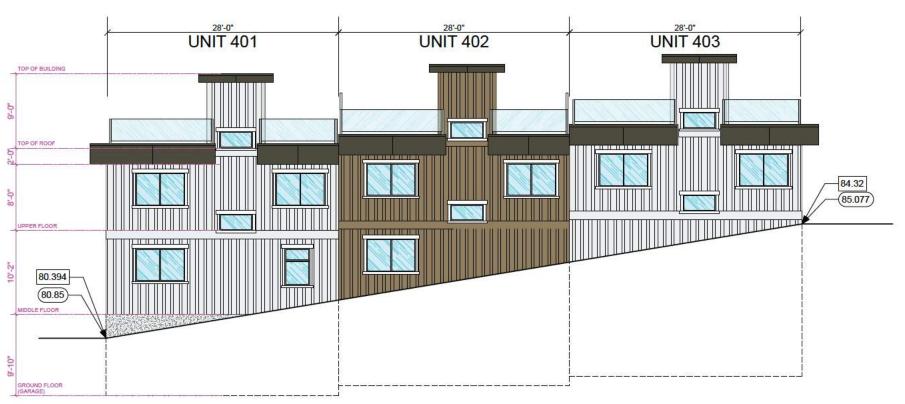

**BUILDING #4 REAR ELEVATION (WEST)**  DVP 3090-24-02 670 Farrell Road

22/09/27 DESIGN DEVELOPMENT 23/02/13 DESIGN DEVELOPMENT 23/06/16 DESIGN DEVELOPMENT - PRE APPLICATION MEETIN 23/09/16 DEVELOPMENT PERMIT COORDINATION 23/09/25 FINAL DESIGN 23/10/27 DEVT PHASING PLAN 23/12/01 ISSUED FOR DEVELOPMENT PERMIT 24/01/07 SITE FORMATION 24/01/27 MAJOR SITE REVISION PER DP COMMENTS 24/02/01 REVISED PER SITE SURVEY (GRADES) UPDATE 24/02/08 UPDATE SITE SECTIONS 24/02/16 UPDATE SITE PLAN W/FIRE TRUCK PATH 24/03/03 ADD FIRE TRUCK TURNAROUND AND REDUCE SLOPES, REVISED SITE PLAN BLDGS 4, 5, 6 & 7, DELETE ONE UNIT 24/03/14 REVISED DRIVEWAYS, RET WALLS, ROAD SLOPES

DO NOT SCALE OFF DRAWING. THIS DRAWING IS NOT FOR CONSTRUCTION PURPOSES UNLESS EXPRESSLY STATED. ALL RIGHTS RESERVED AND REPRODUCTION IN ANY FORM MUST BE APPROVED BY G3 ARCHITECTURE INC.



G3 ARCHITECTURE INC. #130 - 1959 - 152ND STREET SURREY, B.C.

TEL: 604-916-8582 EMAIL: gus@g3projects.com

THE ARKELL RESIDENTIAL DEVELOPMENT 670 FARRELL ROAD LADYSMITH, BC DEVELOPMENT PERMIT #DP22-14

88.123 INDICATES EXISTING GRADE

(88.123) INDICATES FINISHED GRADE

TOWNHOME **BUILDING #4** FRONT & REAR ELEVATION

SCALE 3/16" = 1'-0" **DP340** 24/03/29

Schedule B - Elevation Plans DVP 3090-24-02 670 Farrell Road (2 of 8)




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SIDE ELEVATION (SOUTH)

88.123 INDICATES EXISTING GRADE

88.123 INDICATES FINISHED GRADE

THE ARKELL
RESIDENTIAL DEVELOPMENT
670 FARRELL ROAD
LADYSMITH, BC
DEVELOPMENT PERMIT #DP22-14

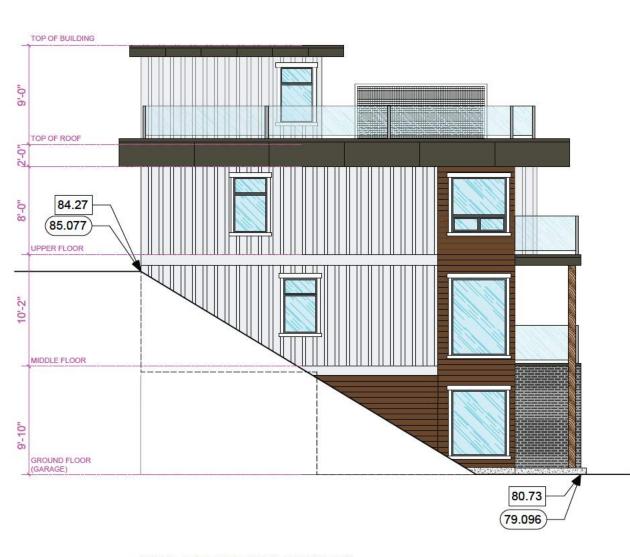DEVELOPMENT PER

TOWNHOME BUILDING #4 SIDE ELEVATIONS

DATE: 24/03/29 DRAWING NO.: DP341

Page 40 of 159

80.85

81.274

TOP OF BUILDING

TOP OF ROOF

UPPER FLOOR

MIDDLE FLOOR

GROUND FLOOR

78.56

SIDE ELEVATION (NORTH)



THE ARKELL

**DP360** 

Schedule B - Elevation Plans DVP 3090-24-02 670 Farrell Road (4 of 8)


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G3 ARCHITECTURE INC. #130 - 1959 - 152ND STREET SURREY, B.C.

TEL: 604-916-8582 EMAIL: gus@g3projects.com



SIDE ELEVATION (NORTH)

80.80

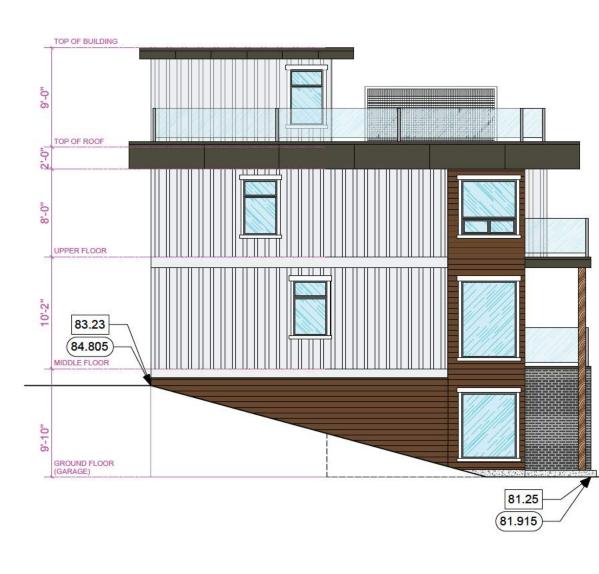(81.204)

TOP OF BUILDING

TOP OF ROOF

UPPER FLOOR

MIDDLE FLOOR

GROUND FLOOR

SIDE ELEVATION (SOUTH)

88.123 INDICATES EXISTING GRADE 88.123 INDICATES FINISHED GRADE


THE ARKELL RESIDENTIAL DEVELOPMENT 670 FARRELL ROAD LADYSMITH, BC DEVELOPMENT PERMIT #DP22-14


TOWNHOME **BUILDING #6** SIDE ELEVATIONS

SCALE DRAWING NO .: 1/4" = 1'-0" **DP361** 24/03/29


84.28

86.500

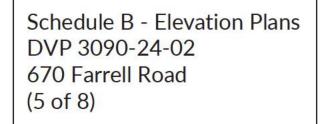

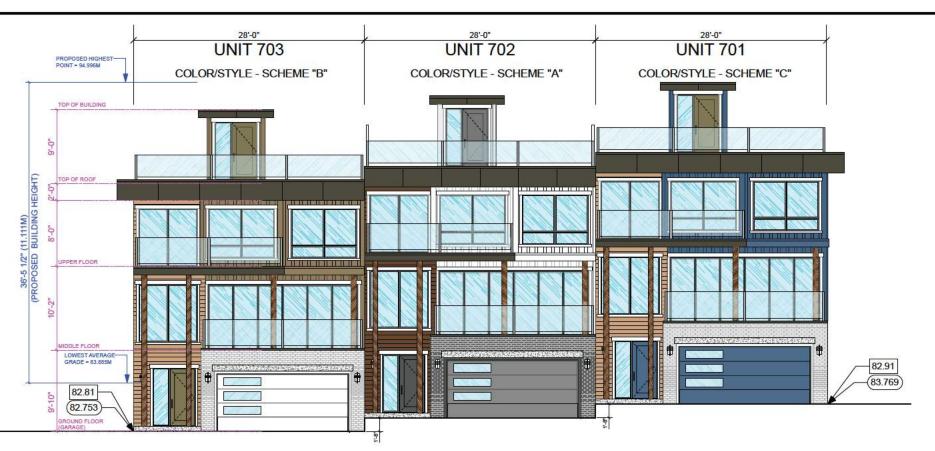

## BUIIDING #7 FRONT ELEVATION (EAST)

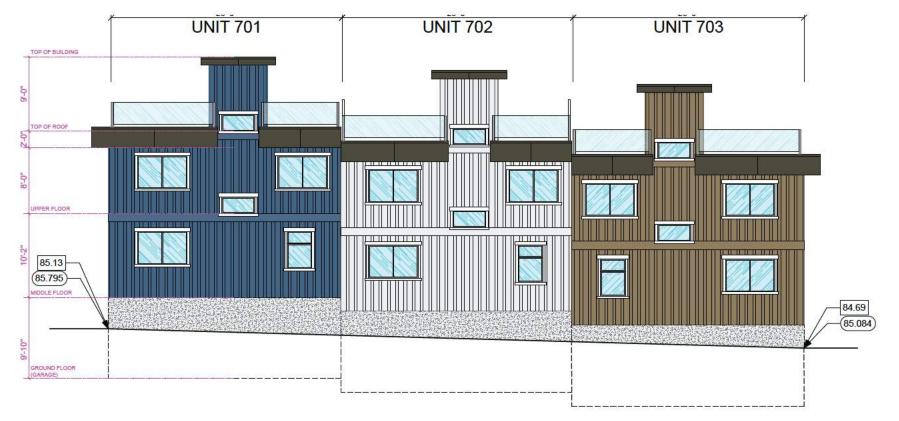

BUILDING #7
REAR ELEVATION (WEST)



## 22/09/27 DESIGN DEVELOPMENT 23/02/13 DESIGN DEVELOPMENT 23/06/16 DESIGN DEVELOPMENT - PRE APPLICATION MEETING 23/09/16 DEVELOPMENT PERMIT COORDINATION 23/09/25 FINAL DESIGN 23/10/27 DEVIT PHASING PLAN 23/10/27 DEVT PHASING PLAN 24/01/07 SITE FORMATION 24/01/07 SITE FORMATION 24/01/27 MAJOR SITE REVISION PER DP COMMENTS 24/02/01 REVISED PER SITE SURVEY (GRADES) UPDATE 24/02/01 UPDATE SITE PLAN WIFIRE TRUCK PATH 24/03/03 ADD FIRE TRUCK TURNAROUND AND REDUCE SLOPES, REVISED SITE PLAN BLOGS 4, 5, 6 3, 7, DELETE ONE UNIT 24/03/14 REVISED DIS MEAVING, RET WALLS, RADO SLOPES 24/03/29 REVISED BRILDONDRIVEWAYS 1, 2 4 3, REVO GRADESHEIGHTS

DO NOT SCALE OFF DRAWING. THIS DRAWING IS NOT FOR CONSTRUCTION PURPOSES UNLESS EXPRESSLY STATED. ALL RIGHTS RESERVED AND REPRODUCTION IN ANY FORM MUST BE APPROVED BY G3 ARCHITECTURE INC.



G3 ARCHITECTURE INC. #130 - 1959 - 152ND STREET SURREY, B.C.

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THE ARKELL
RESIDENTIAL DEVELOPMENT
670 FARRELL ROAD
LADYSMITH, BC
DEVELOPMENT PERMIT #DP22-14

TITLE:

TOWNHOME BUILDING #7 FRONT & REAR ELEVATION

SCALE: DRAWING NO.:


DATE: 24/03/29


DRAWING NO.:

DP370

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DVP 3090-24-02 670 Farrell Road (6 of 8)



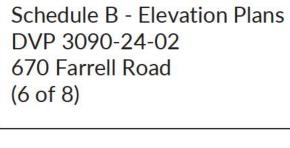

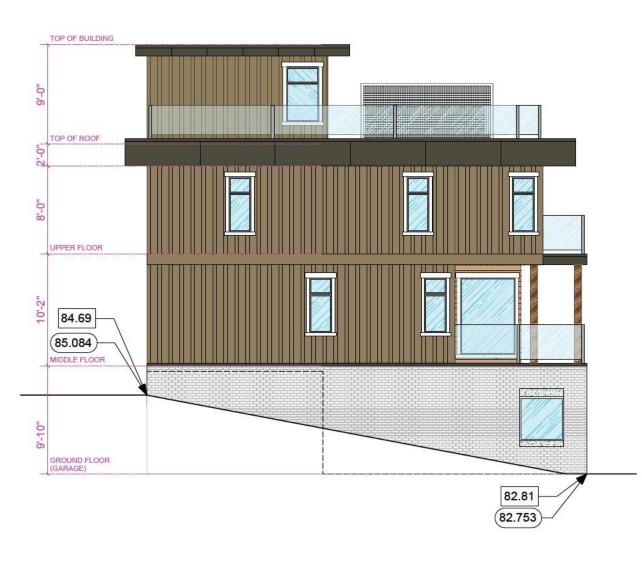SIDE ELEVATION (NORTH)

TOP OF BUILDING

TOP OF ROOF

UPPER FLOOR

MIDDLE FLOOR

GROUND FLOOR (GARAGE)

82.91 83.769

SIDE ELEVATION (SOUTH)



	22/09/27	DESIGN DEVELOPMENT
	23/02/13	DESIGN DEVELOPMENT
	23/06/16	DESIGN DEVELOPMENT - PRE APPLICATION MEETING
	23/09/16	DEVELOPMENT PERMIT COORDINATION
	23/09/25	FINAL DESIGN
	23/10/27	DEVT PHASING PLAN
	23/12/01	ISSUED FOR DEVELOPMENT PERMIT
	24/01/07	SITE FORMATION
	24/01/27	MAJOR SITE REVISION PER DP COMMENTS
	24/02/01	REVISED PER SITE SURVEY (GRADES) UPDATE
	24/02/08	UPDATE SITE SECTIONS
	24/02/16	UPDATE SITE PLAN W/FIRE TRUCK PATH
	24/03/03	ADD FIRE TRUCK TURNAROUND AND REDUCE SLOPES, REVISED SITE PLAN BLDGS 4, 5, 6 & 7, DELETE ONE UNIT
	24/03/14	REVISED DRIVEWAYS, RET WALLS, ROAD SLOPES
ı	24/03/29	REVISED BLDGS/DRIVEWAYS 1, 2 & 3, REVD GRADES/HEIGHTS

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G3 ARCHITECTURE INC. #130 - 1959 - 152ND STREET SURREY, B.C. V4A 0C4

TEL: 604-916-8582 EMAIL: gus@g3projects.com

THE ARKELL RESIDENTIAL DEVELOPMENT 670 FARRELL ROAD LADYSMITH, BC DEVELOPMENT PERMIT #DP22-14

TOWNHOME BUILDING #7 SIDE ELEVATIONS

DRAWING NO .: 1/4" = 1'-0" **DP371** 24/03/29

85.13 85.795





### ATTACHMENT C



## TOWN OF LADYSMITH DEVELOPMENT PERMIT

(Section 489 Local Government Act)

FILE NO: 3060-22-14

DATE: May 21, 2024

Name of Owner(s) of Land (Permittee): Arkell Apartments Ltd., Inc. No. BC1453834

Applicant: Adam Kelln, Robyn Kelln, Gustavo Da Roza (G3 Architecture Inc.)

Subject Property (Civic Address): 670 Farrell Road

- 1. This Development Permit is subject to compliance with all of the bylaws of the Town of Ladysmith applicable thereto, except as specifically varied by this Permit.
- 2. This Permit applies to and only to those lands within the Town of Ladysmith described below, and any and all buildings structures and other development thereon:

Lot 12 District Lot 41 Oyster District Plan EPP119981 PID: 032-050-844 (670 Farrell Road)

(referred to as the "Land)

- 3. This Permit has the effect of authorizing the issuance of a building permit for the construction of a residential development consisting of two four-storey multiple-unit dwelling buildings, three four-unit townhouse buildings, four threeunit townhouse buildings, the alteration of land, and construction of accessory buildings and structures on the Land in accordance with the plans and specifications attached to this Permit, and subject to the conditions, requirements and standards imposed and agreed to in this Permit.
- 4. This Permit does not have the effect of varying the use or density of the Land specified in Zoning Bylaw 2014, No. 1860.
- 5. The Permittee, as a condition of the issuance of this Permit, agrees to:

- (a) Develop the Land in accordance with:
  - Schedule A Site Plan
  - Schedule B Phasing Plan
  - Schedule C Building Elevations and Materials
  - Schedule D Landscape Plan
  - Schedule E Landscape Tree Plan
  - Schedule F Stormwater Management Plan
  - Schedule G Waste Management Plan
  - Schedule H Geotechnical Assessment
  - Schedule J Erosion and Sediment Control Plan
  - Schedule K Bird Nesting Report
- (b) Provide high efficiency/water saving irrigation to landscaped areas.
- (c) Screen all visible rooftop and exterior mechanical and electrical equipment.
- (d) Follow all recommendations in **Schedule H Geotechnical Assessment** including the following:
  - i. The Geotechnical Engineer will inspect site preparations, subgrade conditions and cutslopes prior to placing fill or concrete.
  - ii. Earthworks preparations should be evaluated by the Geotechnical Engineer prior to installation of formwork.
  - iii. Stormwater management will be in accordance with the recommendations provided in **Schedule F Stormwater Management Plan**.
  - iv. The Geotechnical Engineer will review the building plan and survey for each building prior to construction.
  - v. The Geotechnical Engineer will review any retaining wall construction.
  - vi. Drainage requirements for any wall construction shall be reviewed by the Geotechnical Engineer prior to construction.
  - vii. Follow best management practices to prevent erosion and sedimentation during construction.
- (e) Schedule J Erosion and Sediment Control Plan, and Schedule K Bird Nesting Report including the following:

#### PRIOR TO CONSTRUCTION AND CLEARING

- Erosion and Sediment Control (ESC) measures will be implemented to prevent the mobilization of sediment to the surrounding environment, including the following:
  - a. Limit the area of disturbance to the immediate area of construction.

- b. Delineate the project site boundary with snow fencing or flagging if necessary.
- c. Maintain natural drainage patterns and current drainage structures.
- d. Install sediment fencing at the perimeter of the work area and around stockpiles under the direction and inspection of the Qualified Environmental Professional (QEP).
- ii. Catch basin inlet protection measures will be installed.
- iii. Clearing or grubbing is prohibited during the peak bird nesting season between May 1 July 15.
- iv. Breeding bird nest surveys will be conducted by the QEP if clearing or grubbing is planned to occur during the breeding bird nesting window between March 15 May 1 and between July 15 to August 15.

#### **DURING CONSTRUCTION**

- i. Runoff in the work site must be controlled and managed on site.
- ii. Prevent the tracking of sediment by construction vehicles by maintaining all site access locations.
- iii. Ensure that erosion and sediment control materials are available onsite.
- iv. Install silt fencing at the perimeter of the disturbed work areas and upgradient slope areas.
- v. Apply straw, if necessary, to erodible surfaces.
- vi. Temporary material stockpiles are to be compacted and/or protected from rain and wind with Polyethylene sheeting or tarps.
- vii. Remove, maintain, repair, and/or replace erosion and sediment control structures when deemed inefficient, exhausted, or no longer necessary.
- viii. Disturbed soils left for more than 30 days will be mulched or seeded.
- ix. Clearing and grubbing should be scheduled during dry weather.
- x. During periods of significant rain, the site may be shut down to prevent erosion and the mobilization of sediment.
- xi. All works will be monitored by the QEP during land clearing and construction.
- xii. Hazardous materials, dangerous goods, controlled products, and wastes generated during the project shall be stored, used, transported, and disposed of according to applicable laws and regulations.
- xiii. Follow best practices for dust control measures.
- xiv. Ensure best management practices are followed to prevent spill or release of other hazardous materials to the surrounding environment.


#### POST CONSTRUCTION & LONG-TERM PROTECTION


- i. Earthworks and stabilization plans must be prepared and implemented as follow up activities upon completion of operations.
- ii. Exposed soils should be seeded or covered with other erosion control measures during non-germination periods.

- 6. The Permittee agrees that the sequence and timing of the construction described in this permit shall take place as follows:
  - (a) Construction of the development may proceed in five phases as shown on **Schedule A Site Plan** and **Schedule B Phasing Plan** consisting of:
    - i. Phase 1: Building 1 and Building 2
    - ii. Phase 2: Building 3
    - iii. Phase 3: Building 4 and Building 5
    - iv. Phase 4: Building 6 and Building 7
    - v. Phase 5: Building 8 and Building 9
  - (b) Phase 6 landscape works as shown on Schedule D Landscape Plan must be complete prior to approval of Phase 5 development as shown on Schedule B - Phasing Plan. Phase 6 landscape works will be deemed complete by submitting to the Town of Ladysmith a report from a landscape architect confirming that Phase 6 landscaping conditions have been met.
  - (c) In the event that occupancy of a preceding phase occurs prior to the start of construction of the next phase, the Land shall be maintained in a safe condition with the undeveloped areas of the property to be seeded with ground cover or surrounded by opaque fencing.
- 7. This Permit is issued on the condition that the Permittee has provided to the Town of Ladysmith security in the form of security in accordance with s.502 of the *Local Government Act* to guarantee the performance of the conditions in section 5 and 6 of this Permit respecting landscaping. The security shall be for a period of two years, shall be automatically extended, and shall be payable at the building permit stage for each phase in the following installments:
  - (a) \$110,670 (Phase 1)
  - (b) \$32,638 (Phase 2)
  - (c) \$88,936 (Phase 3)
  - (d) \$152,505 (Phase 4)
  - (e) \$324,280 (Phase 5)
- 8. Should the Permittee fail to satisfy the conditions referred to in section 5 and 6 of this Permit, the Town of Ladysmith may undertake and complete the works required to satisfy the landscaping condition(s) at the cost of the Permittee, and may apply the security in payment of the cost of the work, with any excess to be returned to the Permittee.
- 9. Requests for the release of the security shall be accompanied by a report from a landscape architect confirming that the landscaping conditions in section 6 of this permit have been met. The security may be released in five parts in accordance with the phases identified in section 6 and 7 of this permit.

- 10. Notwithstanding section 7, 8 and 9 of this Permit, should any landscape works of a preceding phase be damaged, the Town of Ladysmith may withhold the security of a subsequent phase until the conditions in section 5 and 6 of this Permit respecting landscaping are met.
- 11. Should there be no default as herein provided, or where a Permit lapses, the Town of Ladysmith shall return any security provided to the Permittee.
- 12. For certainty, any retaining walls or vegetation clearing outside of the immediate development area are subject to an additional Development Permit
- 13. If the Permittee does not substantially start any construction permitted by this Permit within **two years** of the date of this Permit as established by the authorizing resolution date, this Permit shall lapse.
- 14. The plans and specifications attached to this Permit are an integral part of this Permit.
- 15. Notice of this Permit shall be filed in the Land Title Office at Victoria under s.503 of the *Local Government Act*, and upon such filing, the terms of this Permit or any amendment hereto shall be binding upon all persons who acquire an interest in the land affected by this Permit.
- 16. Nothing in this Permit relieves the Permittee from any requirements of any federal, provincial, or Town regulations or from any instruments registered on the title including statutory rights-of-ways, covenants and similar restrictions. In the even of a conflict between this Permit and another regulation or instrument, the rules of the instrument or regulation shall prevail.
- 17. Despite issuance of this permit, construction may not start without a Building Permit or other necessary permits.

AUTHORIZED BY RESOLUTION NO.		PASSED BY THE	COUNCIL	OF	THE
TOWN OF LADYSMITH ON THE	DAY OF	, 202			

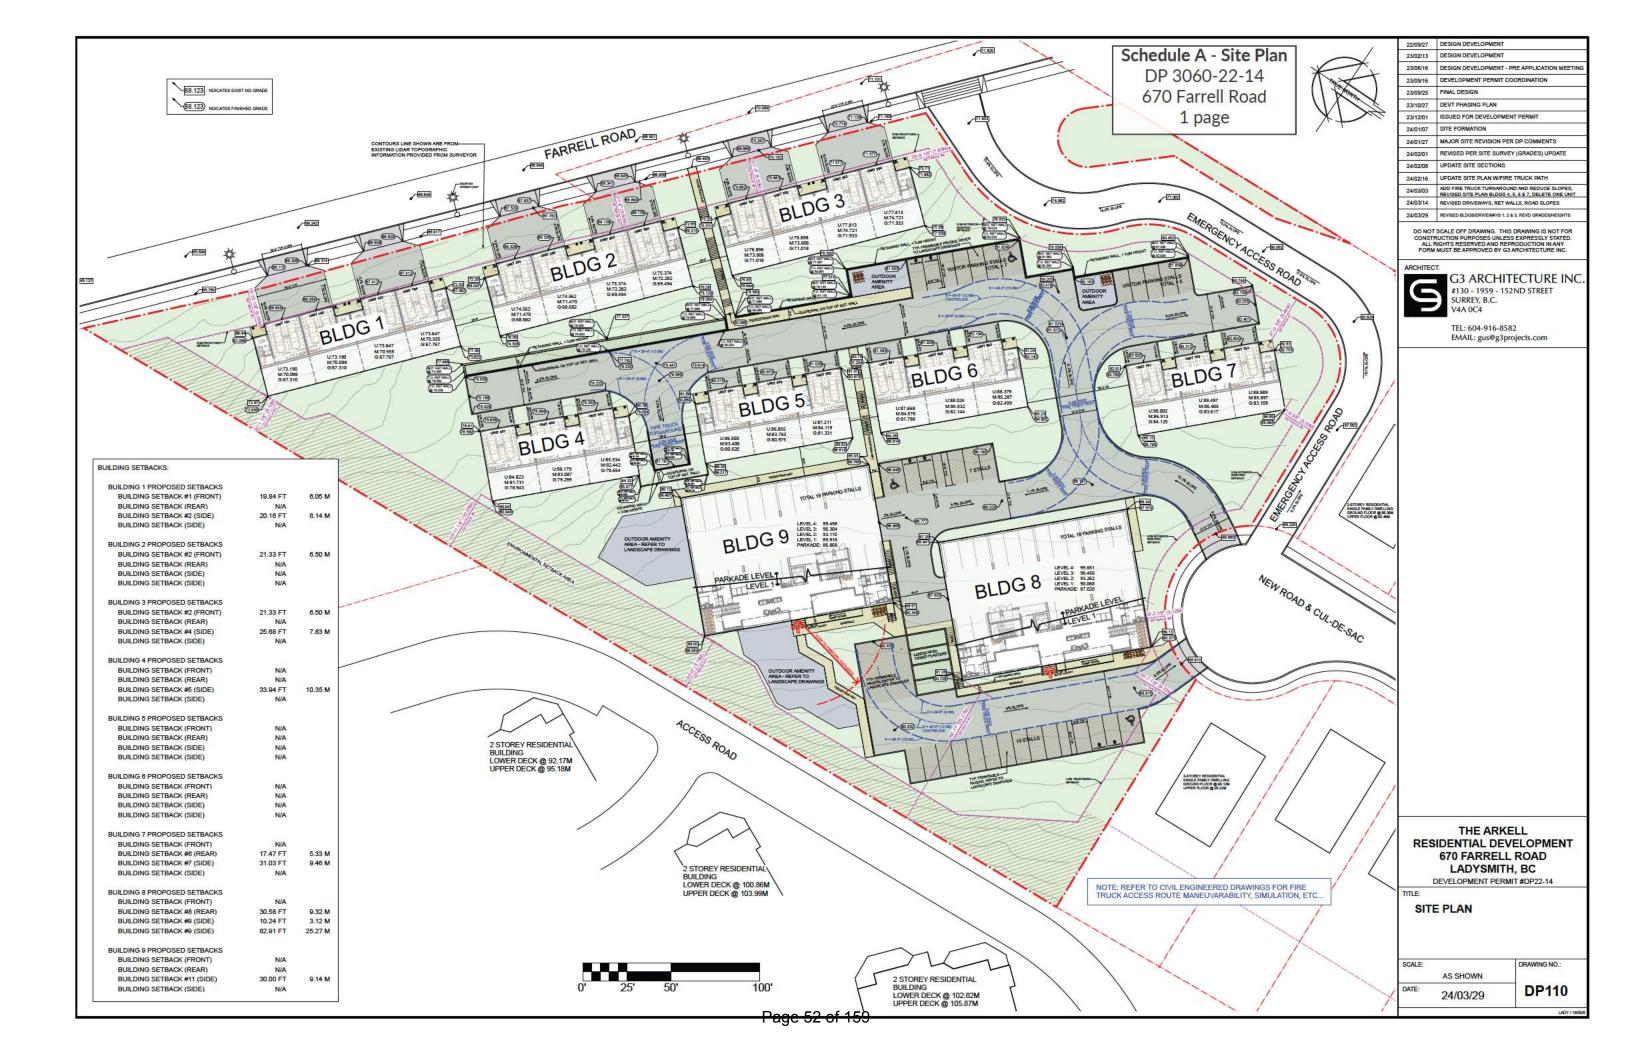


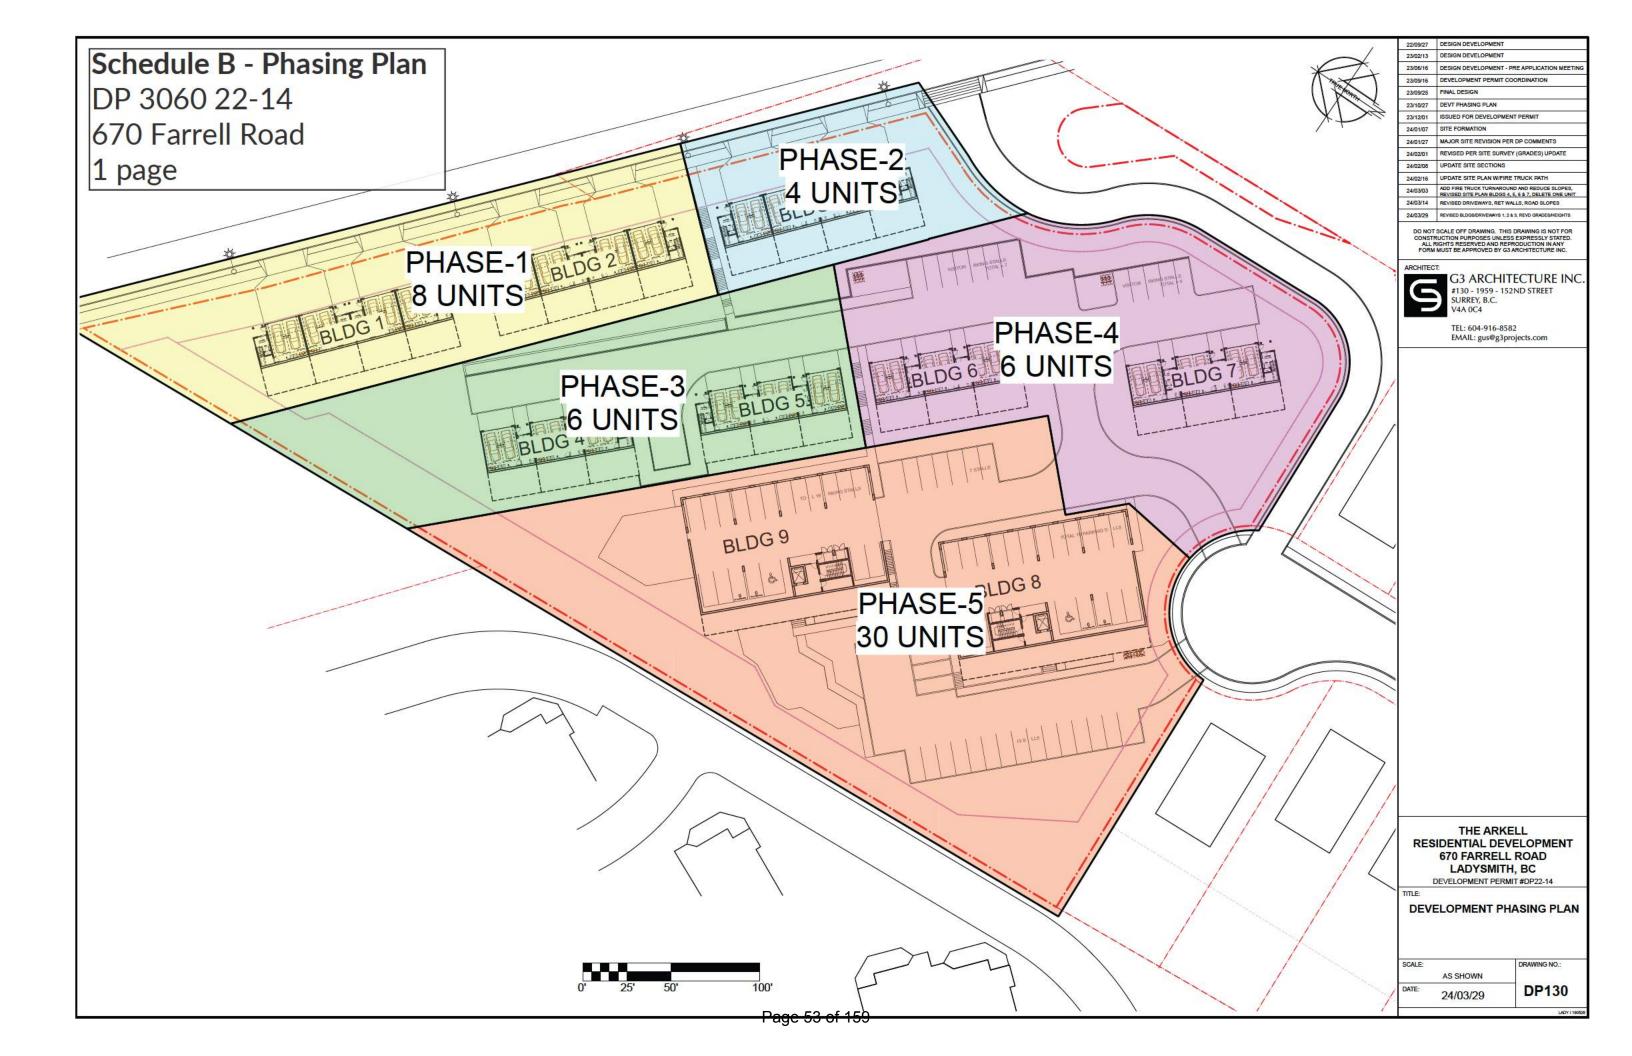







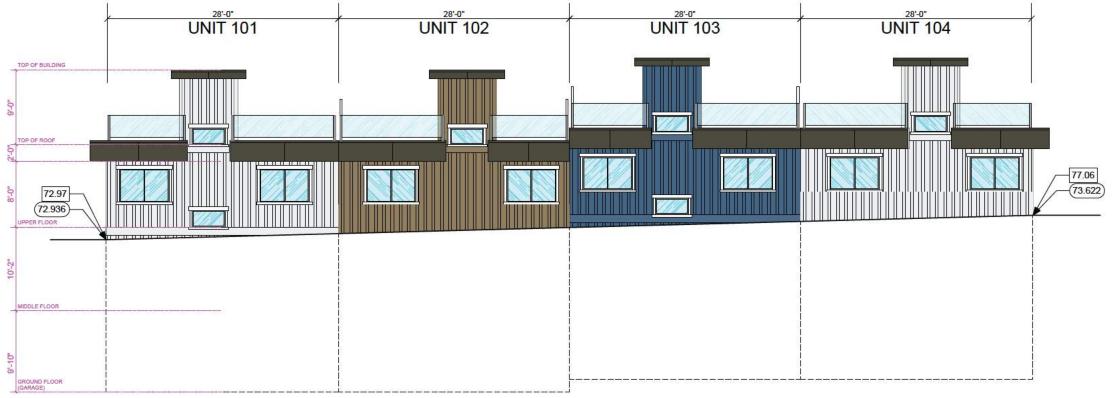

BUILDING #1 REAR ELEVATION (WEST)



22/09/27	DESIGN DEVELOPMENT
23/02/13	DESIGN DEVELOPMENT
23/06/16	DESIGN DEVELOPMENT - PRE APPLICATION MEETING
23/09/16	DEVELOPMENT PERMIT COORDINATION
23/09/25	FINAL DESIGN
23/10/27	DEVT PHASING PLAN
23/12/01	ISSUED FOR DEVELOPMENT PERMIT
24/01/07	SITE FORMATION
24/01/27	MAJOR SITE REVISION PER DP COMMENTS
24/02/01	REVISED PER SITE SURVEY (GRADES) UPDATE
24/02/08	UPDATE SITE SECTIONS
24/02/16	UPDATE SITE PLAN W/FIRE TRUCK PATH
24/03/03	ADD FIRE TRUCK TURNAROUND AND REDUCE SLOPES, REVISED SITE PLAN BLDGS 4, 5, 6 & 7, DELETE ONE UNIT
24/03/14	REVISED DRIVEWAYS, RET WALLS, ROAD SLOPES
24/03/29	REVISED BLDGS/DRIVEWAYS 1, 2 & 3, REVD GRADES/HEIGHTS

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G3 ARCHITECTURE INC. #130 - 1959 - 152ND STREET SURREY, B.C.

TEL: 604-916-8582 EMAIL: gus@g3projects.com

THE ARKELL
RESIDENTIAL DEVELOPMENT
670 FARRELL ROAD
LADYSMITH, BC
DEVELOPMENT PERMIT #DP22-14

LE:

TOWNHOME BUILDING #1 FRONT & REAR ELEVATION

DATE: 24/03/29 DRAWING NO.: DP310

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22/09/27 DESIGN DEVELOPMENT
 23/02/13 DESIGN DEVELOPMENT
 23/06/16 DESIGN DEVELOPMENT - PRE APPLICATION MEETING
 23/09/16 DEVELOPMENT PERMIT COORDINATION
 23/09/25 FINAL DESIGN
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THE ARKELL
RESIDENTIAL DEVELOPMENT
670 FARRELL ROAD
LADYSMITH, BC
DEVELOPMENT PERMIT #DP22-14


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88.123 INDICATES EXISTING GRADE

TOWNHOME BUILDING #1 SIDE ELEVATIONS

DATE: 24/03/29 DRAWING NO.: DP311

(88.123) INDICATES FINISHED GRADE



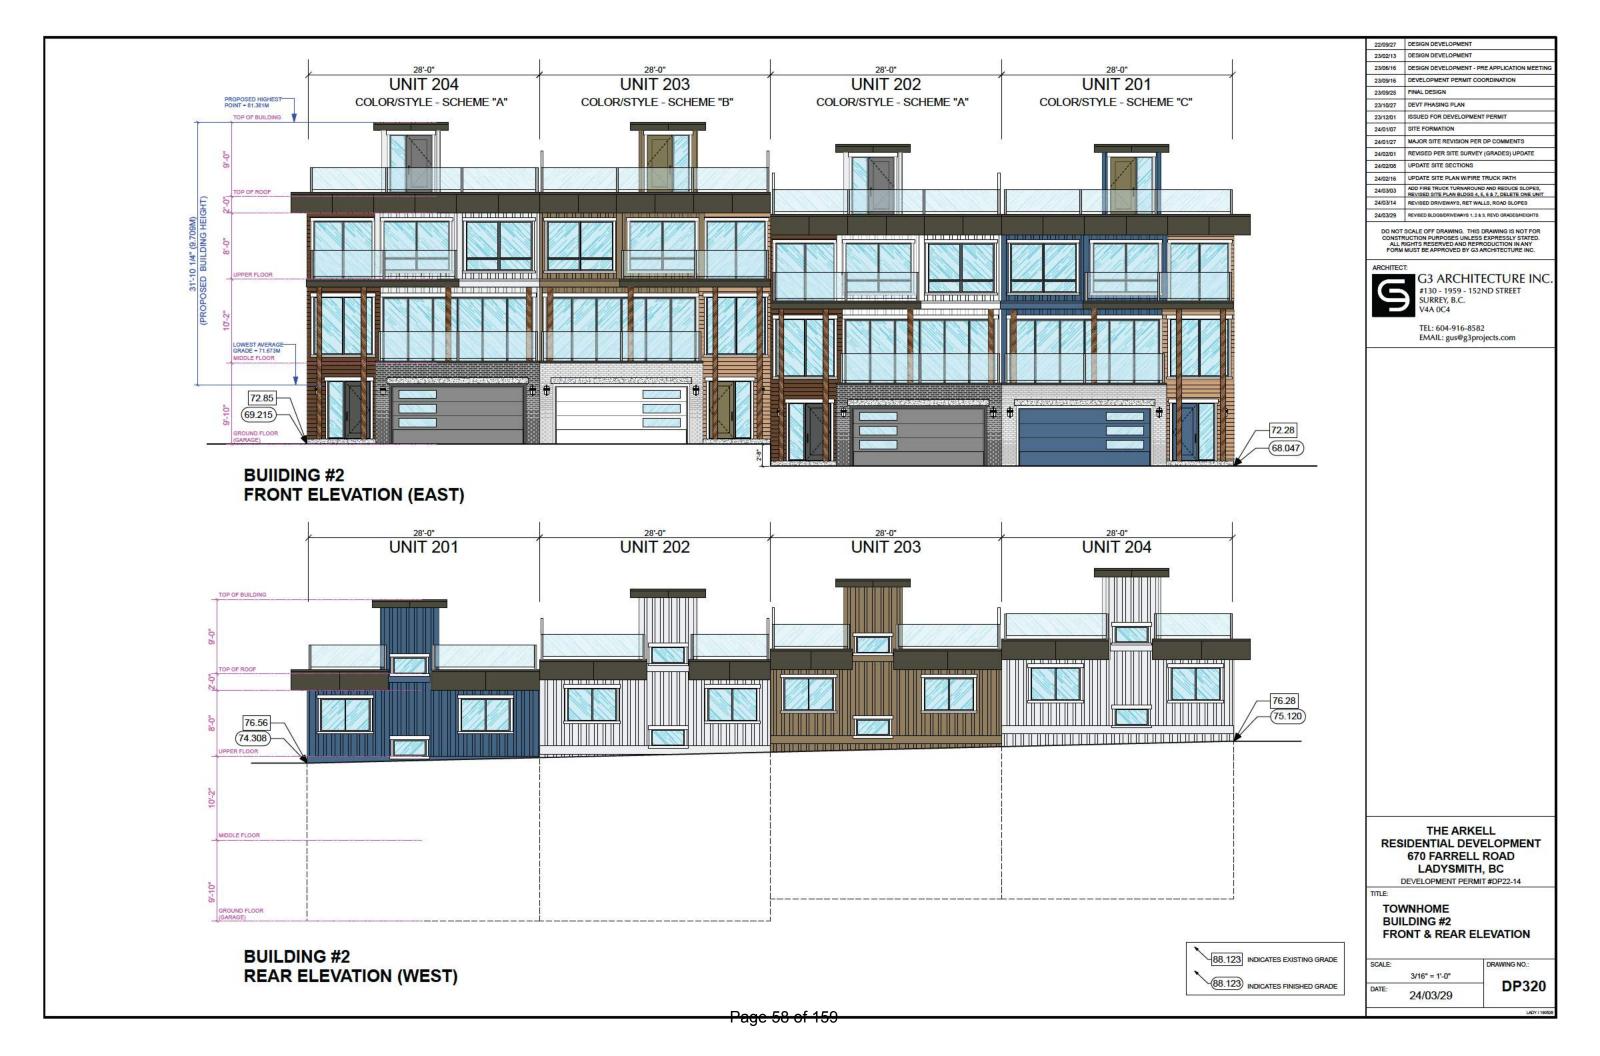

22/09/27 DESIGN DEVELOPMENT
 23/02/13 DESIGN DEVELOPMENT
 23/02/15 DESIGN DEVELOPMENT - PRE APPLICATION MEETING
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THE ARKELL
RESIDENTIAL DEVELOPMENT
670 FARRELL ROAD
LADYSMITH, BC
DEVELOPMENT PERMIT #DP22-14

DEVELO

TOWNHOME BUILDING #2 SIDE ELEVATIONS

DATE: 24/03/29 DRAWING NO.: DP321

SIDE ELEVATION (SOUTH)

88.123 INDICATES EXISTING GRADE

88.123 INDICATES FINISHED GRADE

Page 59 of 159

TOP OF BUILDING

TOP OF ROOF

UPPER FLOOR


MIDDLE FLOOR


GROUND FLOOR (GARAGE)

72.28

SIDE ELEVATION (NORTH)

68.047

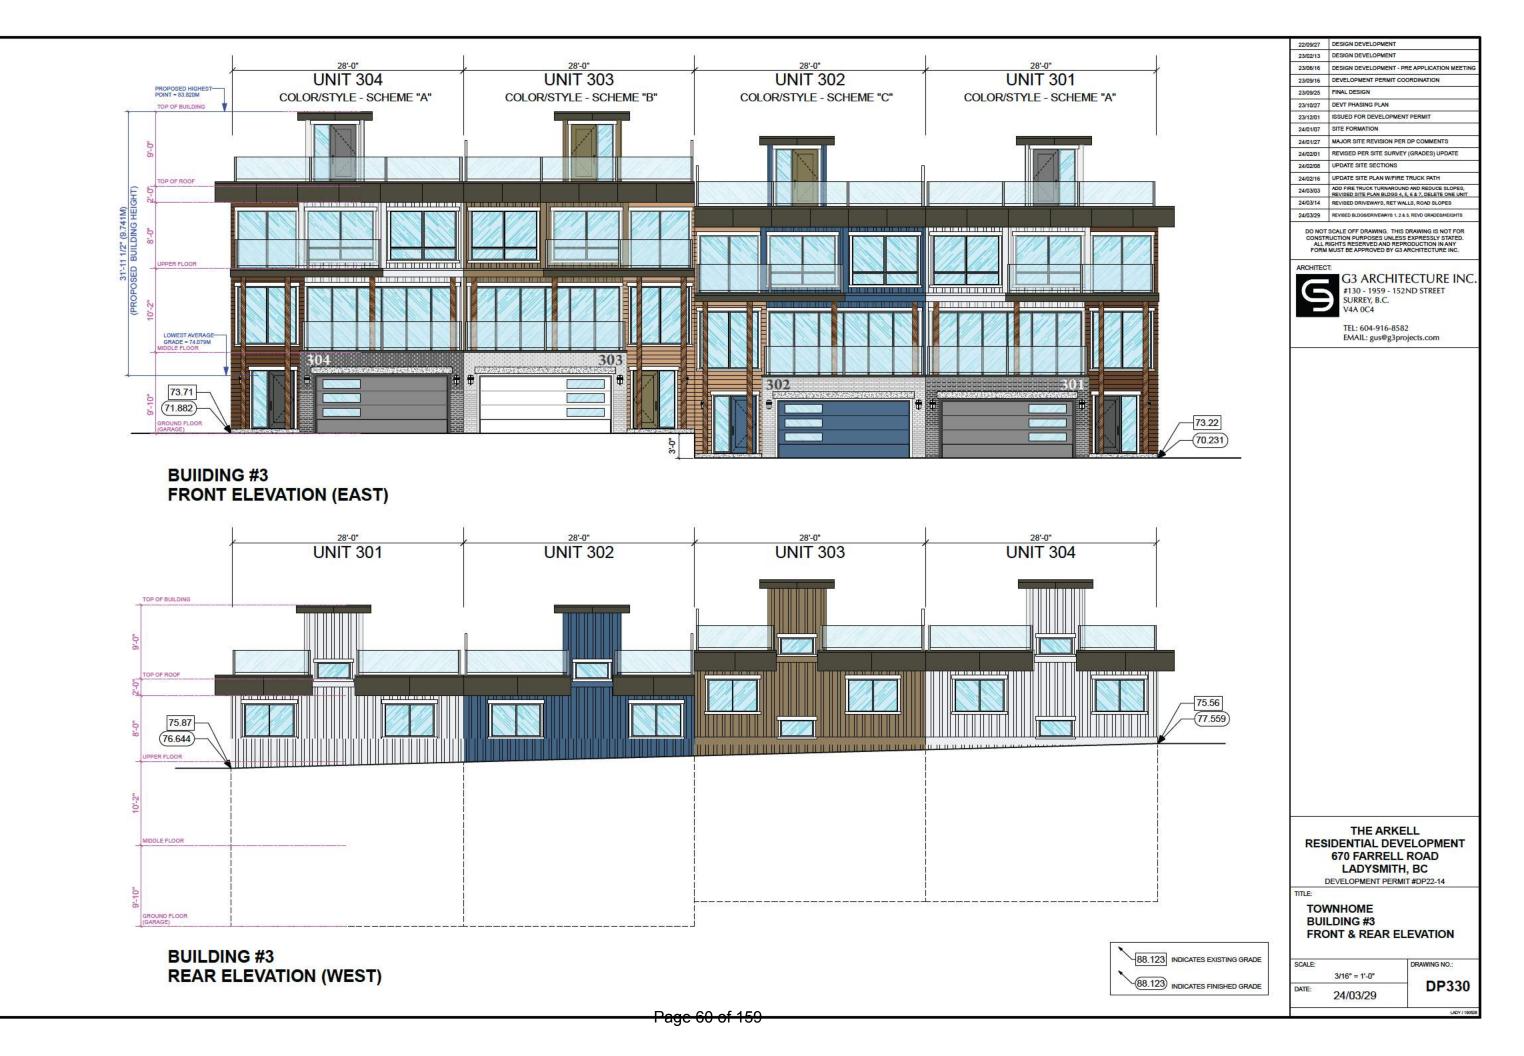

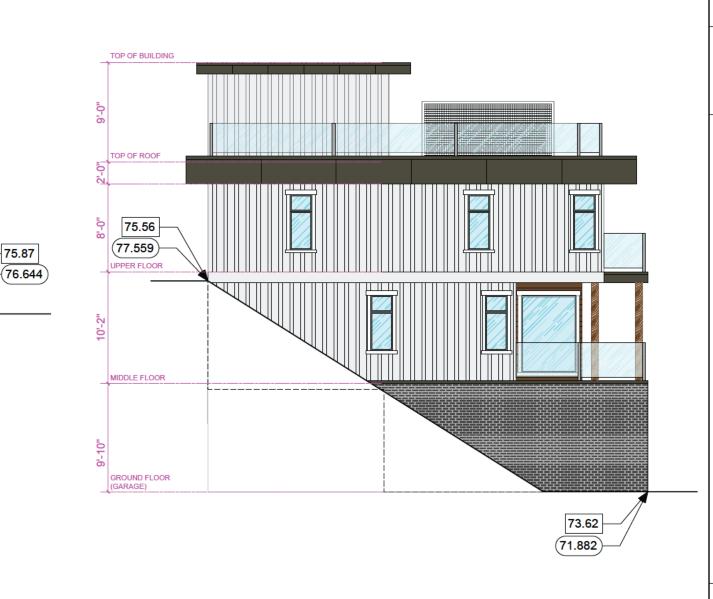

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THE ARKELL
RESIDENTIAL DEVELOPMENT
670 FARRELL ROAD
LADYSMITH, BC
DEVELOPMENT PERMIT #DP22-14

DEVELOPMEN

TOWNHOME BUILDING #3 SIDE ELEVATIONS

DATE: 24/03/29 DRAWING NO.: DP331

**SIDE ELEVATION (SOUTH)** 

88.123 INDICATES EXISTING GRADE

88.123 INDICATES FINISHED GRADE

TOP OF BUILDING

TOP OF ROOF


UPPER FLOOR


MIDDLE FLOOR

GROUND FLOOR (GARAGE)


72.88

SIDE ELEVATION (NORTH)

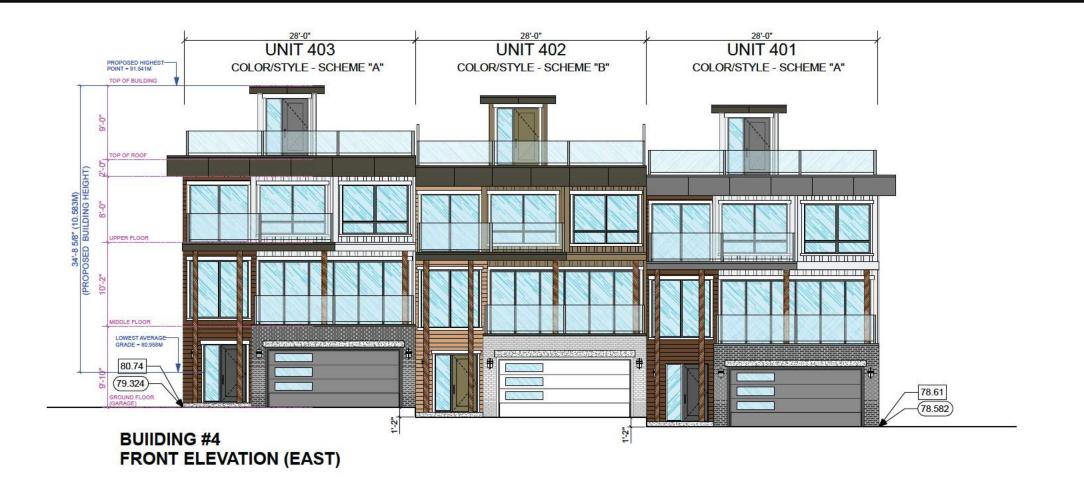

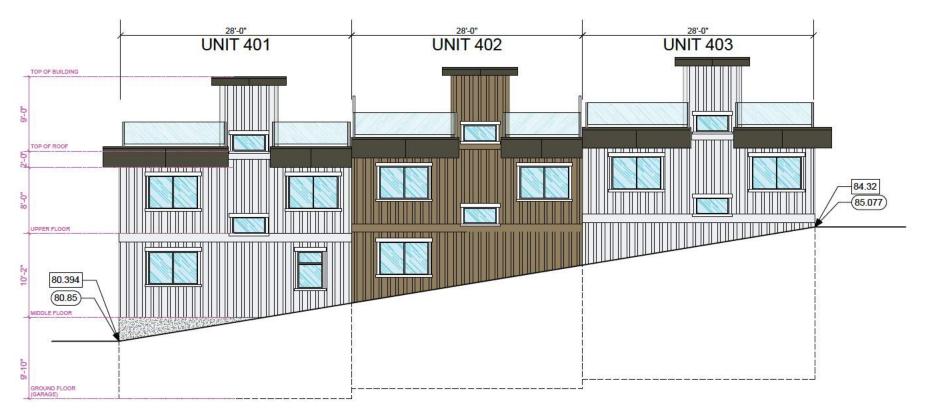

**BUILDING #4 REAR ELEVATION (WEST)** 

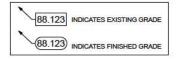

22/09/27 DESIGN DEVELOPMENT 23/02/13 DESIGN DEVELOPMENT 23/06/16 DESIGN DEVELOPMENT - PRE APPLICATION MEETING 23/09/16 DEVELOPMENT PERMIT COORDINATION 23/09/25 FINAL DESIGN 23/10/27 DEVT PHASING PLAN 23/12/01 ISSUED FOR DEVELOPMENT PERMIT 24/01/07 SITE FORMATION 24/01/27 MAJOR SITE REVISION PER DP COMMENTS 24/02/01 REVISED PER SITE SURVEY (GRADES) UPDATE 24/02/08 UPDATE SITE SECTIONS 24/02/16 UPDATE SITE PLAN W/FIRE TRUCK PATH 24/03/03 ADD FIRE TRUCK TURNAROUND AND REDUCE SLOPES, REVISED SITE PLAN BLDGS 4, 5, 6 & 7, DELETE ONE UNIT 24/D3/14 REVISED DRIVEWAYS, RET WALLS, ROAD SLOPES

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THE ARKELL RESIDENTIAL DEVELOPMENT 670 FARRELL ROAD LADYSMITH, BC DEVELOPMENT PERMIT #DP22-14

TOWNHOME **BUILDING #4** FRONT & REAR ELEVATION

SCALE 3/16" = 1'-0" **DP340** 24/03/29



22/09/27 DESIGN DEVELOPMENT
 23/02/13 DESIGN DEVELOPMENT
 23/02/13 DESIGN DEVELOPMENT - PRE APPLICATION MEETING
 23/09/16 DEVELOPMENT PERMIT COORDINATION
 23/09/25 FINAL DESIGN
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 23/10/201 ISSUED FOR DEVELOPMENT PERMIT
 24/01/107 SITE FORMATION
 24/01/27 MAJOR SITE REVISION PER DP COMMENTS
 24/02/101 REVISED PER SITE SURVEY (GRADES) UPDATE
 24/02/103 UPDATE SITE SECTIONS
 24/02/16 UPDATE SITE PLAN WIFIRE TRUCK PATH
 24/03/03 ADD FIRE TRUCK TURNAROUND AND REDUCE SLOPES, REVISED BITE PLAN BLIDS 4, 5, 6 3.7, DELETE ONE UNIT
 24/03/14 REVISED BLOADGRIFEWAYS 1, 24.3, REVO GRADESHEIGHTS

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THE ARKELL
RESIDENTIAL DEVELOPMENT
670 FARRELL ROAD
LADYSMITH, BC
DEVELOPMENT PERMIT #DP22-14

DEVELO

88.123 INDICATES EXISTING GRADE

88.123 INDICATES FINISHED GRADE


TOWNHOME BUILDING #4 SIDE ELEVATIONS

DATE: 24/03/29 DRAWING NO.:


DATE: DATE: DP341

Page 63 of 159



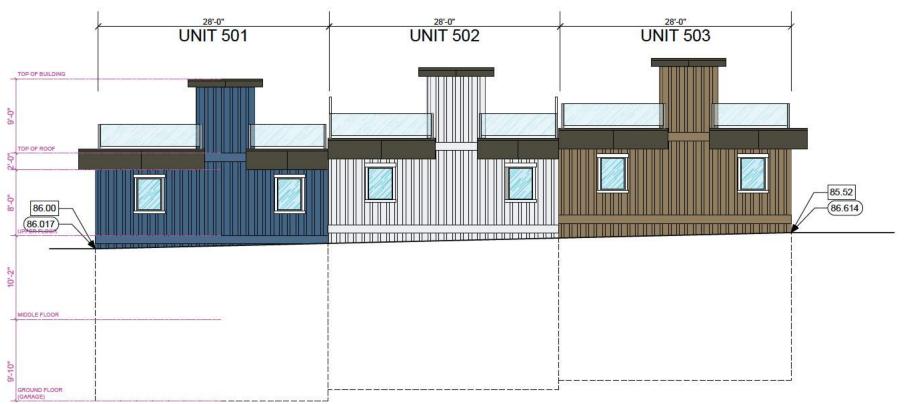

BUILDING #5 REAR ELEVATION (WEST)

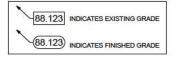

22/09/27	DESIGN DEVELOPMENT
23/02/13	DESIGN DEVELOPMENT
23/06/16	DESIGN DEVELOPMENT - PRE APPLICATION MEETING
23/09/16	DEVELOPMENT PERMIT COORDINATION
23/09/25	FINAL DESIGN
23/10/27	DEVT PHASING PLAN
23/12/01	ISSUED FOR DEVELOPMENT PERMIT
24/01/07	SITE FORMATION
24/01/27	MAJOR SITE REVISION PER DP COMMENTS
24/02/01	REVISED PER SITE SURVEY (GRADES) UPDATE
24/02/08	UPDATE SITE SECTIONS
24/02/16	UPDATE SITE PLAN W/FIRE TRUCK PATH
24/03/03	ADD FIRE TRUCK TURNAROUND AND REDUCE SLOPES, REVISED SITE PLAN BLDGS 4, 5, 6 & 7, DELETE ONE UNIT
24/03/14	REVISED DRIVEWAYS, RET WALLS, ROAD SLOPES
24/03/29	REVISED BLDGS/DRIVEWAYS 1, 2 & 3, REVD GRADES/HEIGHTS

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THE ARKELL
RESIDENTIAL DEVELOPMENT
670 FARRELL ROAD
LADYSMITH, BC
DEVELOPMENT PERMIT #DP22-14

TITLE:

TOWNHOME BUILDING #5 FRONT & REAR ELEVATION

SCALE: 3/16" = 1'-0" DRAWING NO.:

DATE: 24/03/29 DP350

140



22/09/27 DESIGN DEVELOPMENT
23/02/13 DESIGN DEVELOPMENT
23/02/13 DESIGN DEVELOPMENT - PRE APPLICATION MEETING
23/09/16 DEVELOPMENT - PRE APPLICATION MEETING
23/09/25 FINAL DESIGN
23/10/27 DEVT PHASING PLAN
23/10/27 DEVT PHASING PLAN
23/12/21 ISSUED FOR DEVELOPMENT PERMIT
23/12/21 ISSUED FOR DEVELOPMENT PERMIT
24/01/21 SITE FORMATION
24/01/27 MAJOR SITE REVISION PER DP COMMENTS
24/02/20 UPDATE SITE SURVEY (GRADES) UPDATE
24/02/20 UPDATE SITE SECTIONS
24/02/216 UPDATE SITE PLAN WIFIRE TRUCK PATH
24/03/03 ADD FRE TRUCK TURNAROUND NOR REDUCE GLOPES,
REVISED SITE PLAN BLOSG 4, 5, 6 17, DELETE ONE UNIT
24/03/14 REVISED DRIVENMYS, RET WALLS, ROAD GRADESHEIGHTS
DO NOT SCALE OFF DRAWING IT HIS DRAWING IS NOT FOR

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TEL: 604-916-8582 EMAIL: gus@g3projects.com

THE ARKELL
RESIDENTIAL DEVELOPMENT
670 FARRELL ROAD
LADYSMITH, BC
DEVELOPMENT PERMIT #DP22-14

TITLE:

TOWNHOME BUILDING #5 SIDE ELEVATIONS

DATE: 24/03/29 DRAWING NO.:

DATE: 24/03/29

88.123 INDICATES EXISTING GRADE

88.123 INDICATES FINISHED GRADE



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6

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TEL: 604-916-8582 EMAIL: gus@g3projects.com


THE ARKELL
RESIDENTIAL DEVELOPMENT
670 FARRELL ROAD
LADYSMITH, BC
DEVELOPMENT PERMIT #DP22-14

TITLE:

TOWNHOME BUILDING #6 FRONT & REAR ELEVATION

DATE: 24/03/29 DRAWING NO: DP360

Page 66 of 159

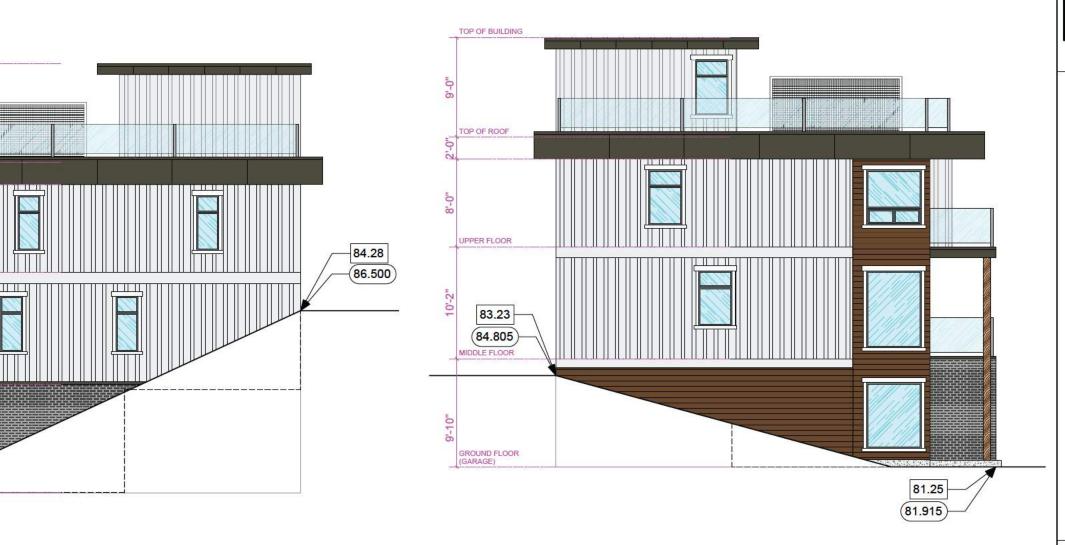

SIDE ELEVATION (SOUTH)

TOP OF BUILDING

TOP OF ROOF

UPPER FLOOR

MIDDLE FLOOR

GROUND FLOOR

80.80

(81.204)

SIDE ELEVATION (NORTH)

22/09/27 DESIGN DEVELOPMENT
 23/02/13 DESIGN DEVELOPMENT
 23/02/13 DESIGN DEVELOPMENT - PRE APPLICATION MEETING
 23/03/16 DESUELOPMENT - PRE APPLICATION MEETING
 23/03/16 DEVELOPMENT PERMIT COORDINATION
 23/03/25 FINAL DESIGN
 23/10/27 DEVT PHASING PLAN
 23/10/27 DEVT PHASING PLAN
 23/10/27 SITE FORMATION
 24/01/27 MAJOR SITE REVISION PER DP COMMENTS
 24/02/01 REVISED PER SITE SURVEY (GRADES) UPDATE
 24/02/01 REVISED PER SITE SURVEY (GRADES) UPDATE
 24/02/01 ADD FIRE TRUCK TURNARGUIND AND REDUCE BLOPES,
 REVISED DITE PLAN BLIDGS 4, 5, 6 & 7, OBLETE ONE UNIT
 24/03/03 REVISED DRIVENAYS, RET WALLS, ROAD SLOPES
 REVISED DRIVENAYS, RET WALLS, ROAD SLOPES
 REVISED DRIVENAYS, RET WALLS, ROAD SLOPES
 REVISED DRIVENAYS, RET WALLS, ROAD SLOPES

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ARCHITECT:

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THE ARKELL
RESIDENTIAL DEVELOPMENT
670 FARRELL ROAD
LADYSMITH, BC
DEVELOPMENT PERMIT #DP22-14

DEVE


88.123 INDICATES EXISTING GRADE

88.123 INDICATES FINISHED GRADE


TOWNHOME BUILDING #6 SIDE ELEVATIONS

DATE: 24/03/29 DRAWING NO.: DP361

Page 67 of 159

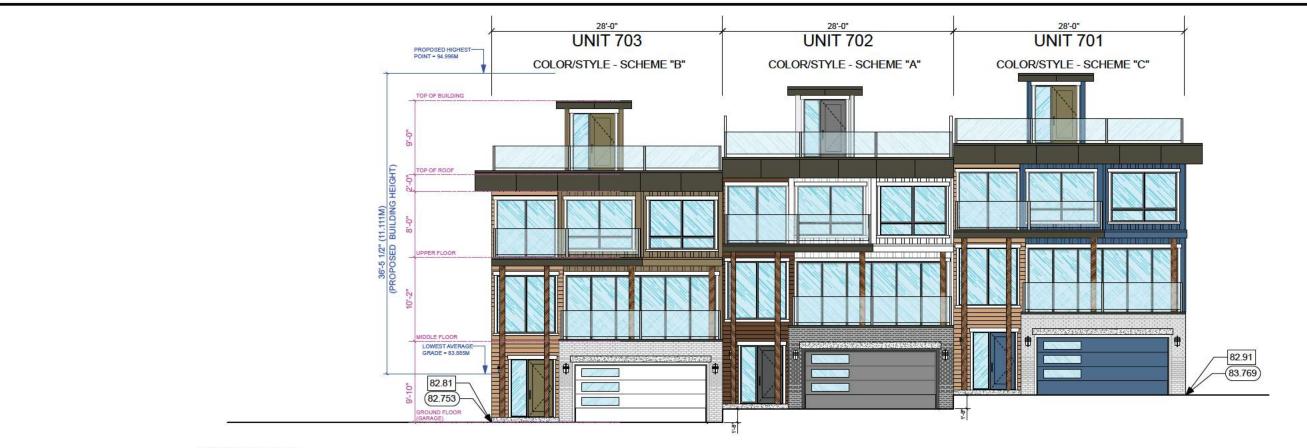

### BUIIDING #7 FRONT ELEVATION (EAST)

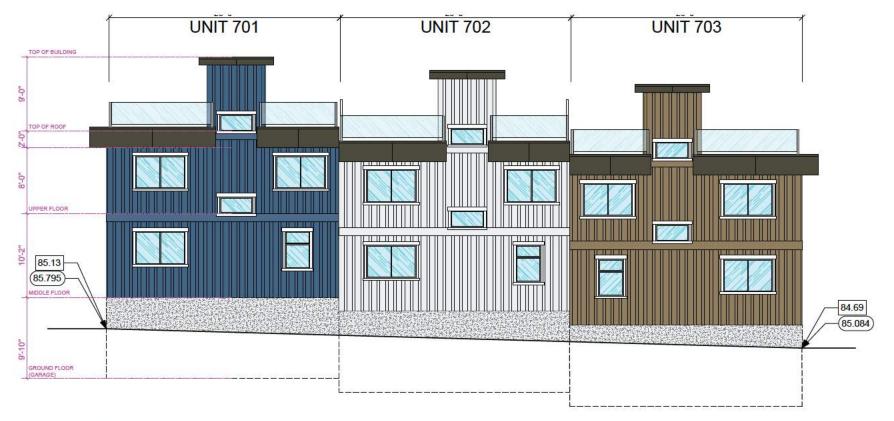

BUILDING #7 REAR ELEVATION (WEST)



# 22/09/27 DESIGN DEVELOPMENT 23/02/13 DESIGN DEVELOPMENT 23/05/16 DESIGN DEVELOPMENT - PRE APPLICATION MEETING 23/05/16 DEVELOPMENT PERMIT COORDINATION 23/09/25 FINAL DESIGN 23/10/27 DEVT PHASING PLAN 23/10/27 DEVT PHASING PLAN 24/01/07 SITE FORMATION 24/01/27 MAJOR SITE REVISION PER DP COMMENTS 24/02/20 REVISED PER SITE SURVEY (GRADES) UPDATE 24/02/20 UPDATE SITE PLAN WIFIRE TRUCK PATH 24/03/03 ADD FRE TRUCK TURNAROUND AND REDUCE BLOPES, REVISED DIRE PLAN BLOSS 4, 5, 6 2, DELETE ONE UNIT 24/03/14 REVISED DIREWAYS, RET WALL, ROAD SLOPES 24/03/29 REVISED BURDADORINEWAYS, 2ET WALL, ROAD SLOPES

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670 FARRELL ROAD
LADYSMITH, BC
DEVELOPMENT PERMIT #DP22-14

TITLE:

TOWNHOME BUILDING #7 FRONT & REAR ELEVATION

DATE: 24/03/29 DRAWING NO.:

DATE: DATE: DP370

Page 68 of 159



SIDE ELEVATION (NORTH)

 22/09/27
 DESIGN DEVELOPMENT

 23/02/13
 DESIGN DEVELOPMENT

 23/06/16
 DESIGN DEVELOPMENT - PRE APPLICATION MEETING

 23/09/16
 DEVELOPMENT PERMIT COORDINATION

 23/09/25
 FINAL DESIGN

 23/10/27
 DEVT PHASING PLAN

 23/12/21
 ISSUED FOR DEVELOPMENT PERMIT

 24/01/01
 SITE FORMATION

 24/01/07
 MAJOR SITE REVISION PER DP COMMENTS

 24/02/01
 REVISED PER SITE SURVEY (GRADES) UPDATE

 24/02/08
 UPDATE SITE SECTIONS

 24/02/16
 UPDATE SITE PLAN WIFIRE TRUCK PATH

 24/03/03
 ADD FIRE TRUCK TURNARQUIND AND REDUCE BLOPES, REVISED SITE PAN BLOSS 4, 5, 6, 4, 7, DELETE ONE UNIT

 24/03/14
 REVISED DRIVENAYS, RET WALLS, ROAD SLOPES

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THE ARKELL
RESIDENTIAL DEVELOPMENT
670 FARRELL ROAD
LADYSMITH, BC
DEVELOPMENT PERMIT #DP22-14

DEVELO

TOWNHOME BUILDING #7 SIDE ELEVATIONS

DATE: 24/03/29 DRAWING NO.: DP371


SIDE ELEVATION (SOUTH)

88.123 INDICATES EXISTING GRADE


88.123 INDICATES FINISHED GRADE



PAINT FINISH: TRIMS, FASCIAS, COLUMNS. COLOR: SW7005 - PURE WHITE

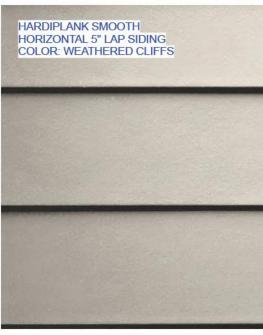



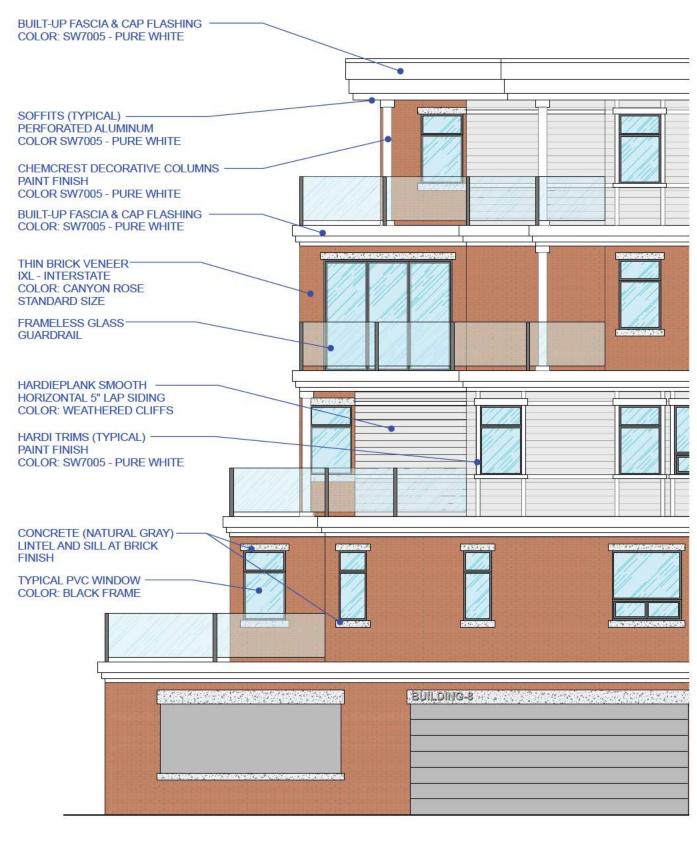

#### NOTE:

NO DARK OR REFLECTIVE GLAZING TO BE USED AT WINDOWS.

WINDOWS FACING HIGHWAY (FARRELL ROAD) TO INCORPORATE SOUND REDUCING GLASS TO MITIGATE NOISE. FINAL SPECIFICATIONS TO BE REVIEWED PRIOR TO CONSTRUCTION

23/06/16 DESIGN DEVELOPMENT - PRE APPLICATION MEETING 23/09/16 DEVELOPMENT PERMIT COORDINATION 23/09/25 FINAL DESIGN 23/10/27 DEVT PHASING PLAN 23/12/01 ISSUED FOR DEVELOPMENT PERMIT 24/01/07 SITE FORMATION 24/01/27 MAJOR SITE REVISION PER DP COMMENTS 24/02/01 REVISED PER SITE SURVEY (GRADES) UPDATE 24/02/08 UPDATE SITE SECTIONS 24/02/16 UPDATE SITE PLAN W/FIRE TRUCK PATH 24/03/03 ADD FIRE TRUCK TURNAROUND AND REDUCE SLOPES, REVISED SITE PLAN BLDGS 4, 5, 6 & 7, DELETE ONE UNIT 24/03/14 REVISED DRIVEWAYS, RET WALLS, ROAD SLOPES DO NOT SCALE OFF DRAWING. THIS DRAWING IS NOT FOR CONSTRUCTION PURPOSES UNLESS EXPRESSLY STATED. ALL RIGHTS RESERVED AND REPRODUCTION IN ANY FORM MUST BE APPROVED BY G3 ARCHITECTURE INC.

22/09/27 DESIGN DEVELOPMENT 23/02/13 DESIGN DEVELOPMENT

G3 ARCHITECTURE INC. #130 - 1959 - 152ND STREET SURREY, B.C.

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THE ARKELL RESIDENTIAL DEVELOPMENT 670 FARRELL ROAD LADYSMITH, BC DEVELOPMENT PERMIT #DP22-14

TYPICAL EXTERIOR FINISHES APARTMENT BUILDINGS BUILDING 8 & 9

SCALE DRAWING NO .: N.T.S. **DP500** 24/03/29

#### PT-1

PAINT FINISH: BOARD N BATTEN COLOR: SW7050 - USEFUL GRAY

PAINT FINISH: BOARD N BATTEN COLOR: SW7514 - FOOTHILLS

PAINT FINISH: ENTRY DOOR, FASCIA COLOR: SW7020 - BLACK FOX

PT-4


PAINT FINISH: GARAGE DOOR & TRIM COLOR: SW7019 - GAUNTLET GRAY

PAINT FINISH: BOARD N BATTEN / DOORS, GARAGE DOOR COLOR: SW6523 - DENIM

PAINT FINISH: GARAGE DOOR/TRIMS COLOR: SW7005 - PURE WHITE





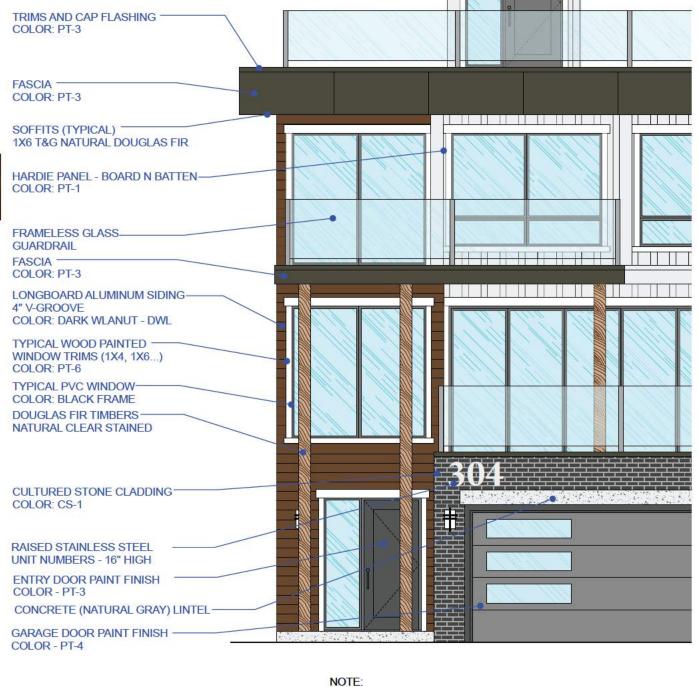

NO DARK OR REFLECTIVE GLAZING TO BE USED AT WINDOWS.

WINDOWS FACING HIGHWAY (FARRELL ROAD) TO INCORPORATE SOUND REDUCING GLASS TO MITIGATE NOISE. FINAL SPECIFICATIONS TO BE REVIEWED PRIOR TO CONSTRUCTION

	22/09/27	DESIGN DEVELOPMENT
	23/02/13	DESIGN DEVELOPMENT
	23/06/16	DESIGN DEVELOPMENT - PRE APPLICATION MEETING
Ī	23/09/16	DEVELOPMENT PERMIT COORDINATION
-	23/09/25	FINAL DESIGN
	23/10/27	DEVT PHASING PLAN
	23/12/01	ISSUED FOR DEVELOPMENT PERMIT
	24/01/07	SITE FORMATION
	24/01/27	MAJOR SITE REVISION PER DP COMMENTS
Ī	24/02/01	REVISED PER SITE SURVEY (GRADES) UPDATE
	24/02/08	UPDATE SITE SECTIONS
	24/02/16	UPDATE SITE PLAN W/FIRE TRUCK PATH
	24/03/03	ADD FIRE TRUCK TURNAROUND AND REDUCE SLOPES, REVISED SITE PLAN BLDGS 4, 5, 6 & 7, DELETE ONE UNIT
Ī	24/03/14	REVISED DRIVEWAYS, RET WALLS, ROAD SLOPES
	24/03/29	REVISED BLDGS/DRIVEWAYS 1, 2 & 3, REVD GRADES/HEIGHTS

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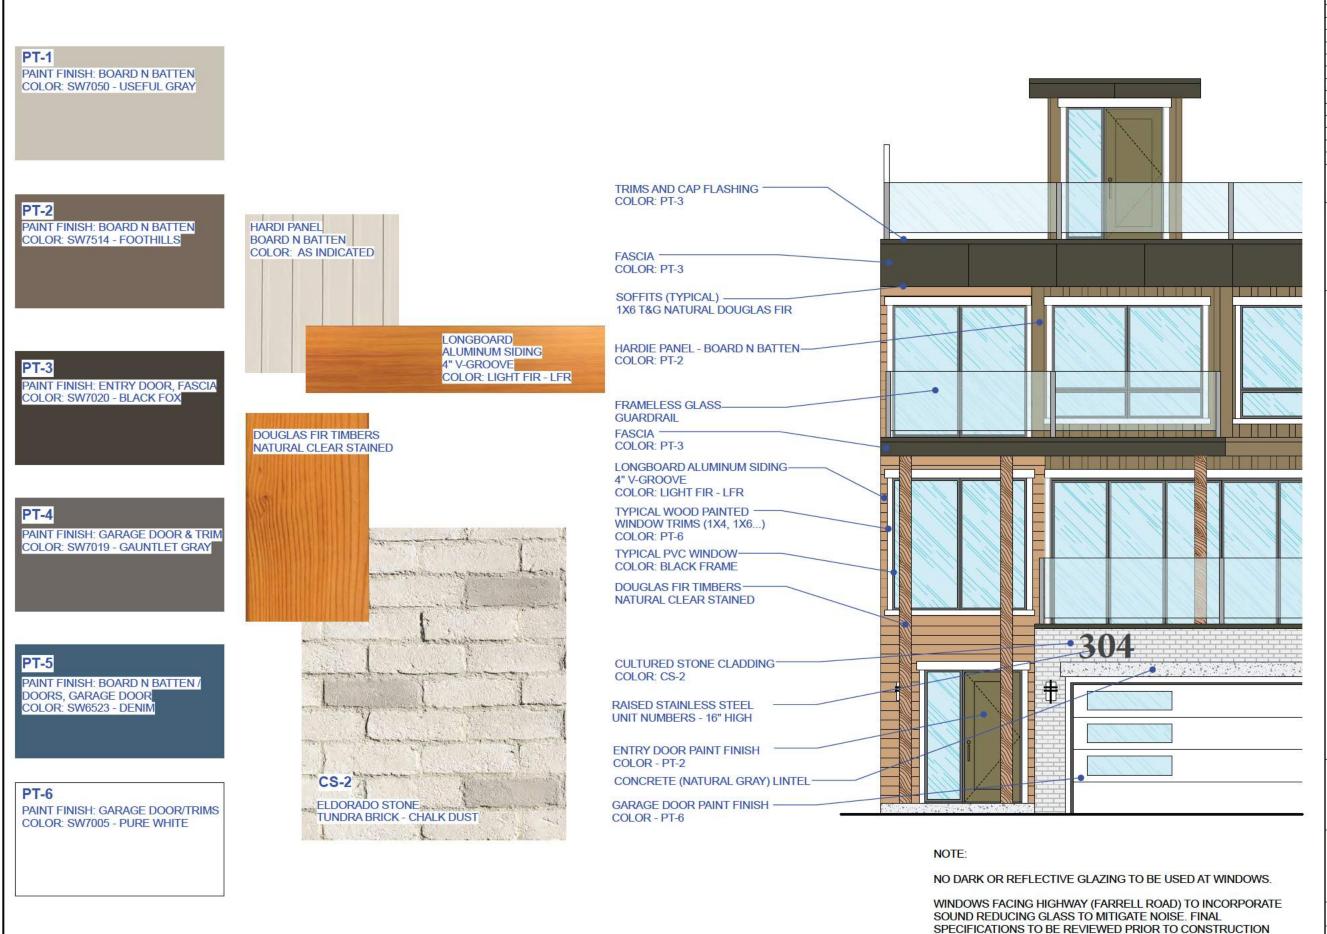
TEL: 604-916-8582 EMAIL: gus@g3projects.com

THE ARKELL RESIDENTIAL DEVELOPMENT 670 FARRELL ROAD LADYSMITH, BC

DEVELOPMENT PERMIT #DP22-14

TYPICAL EXTERIOR FINISHES **TOWNHOUSES** SCHEME A

SCALE DRAWING NO .: N.T.S. **DP510** 24/03/29



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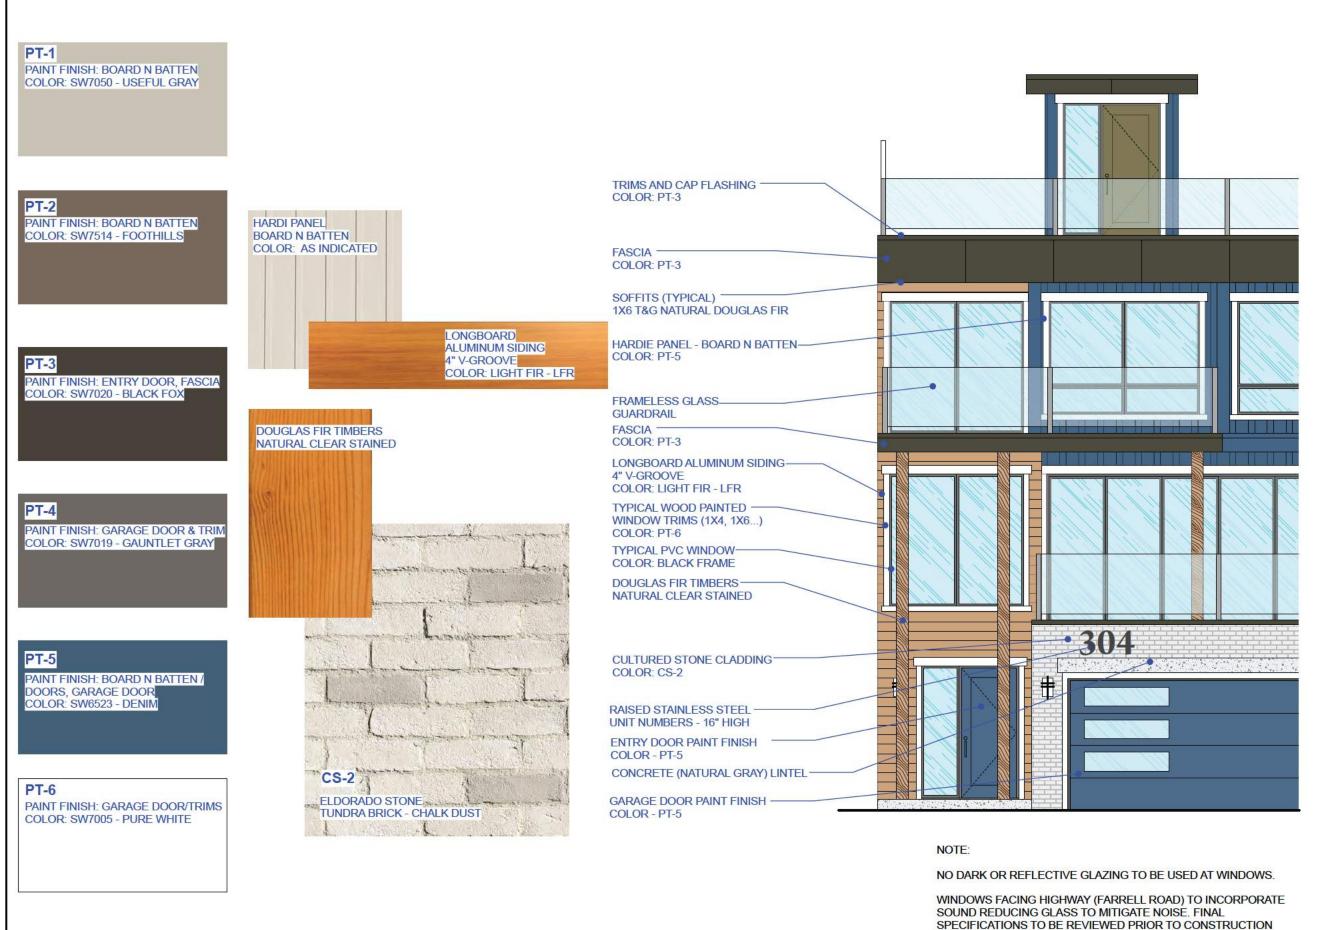
THE ARKELL
RESIDENTIAL DEVELOPMENT
670 FARRELL ROAD
LADYSMITH, BC

DEVELOPMENT PERMIT #DP22-14

TYPICAL EXTERIOR FINISHES TOWNHOUSES SCHEME B

DATE: 24/03/29 DRAWING NO.: DP520

Page 72 of 159



22/09/27 DESIGN DEVELOPMENT 23/02/13 DESIGN DEVELOPMENT 23/06/16 DESIGN DEVELOPMENT - PRE APPLICATION MEETIN 23/09/16 DEVELOPMENT PERMIT COORDINATION 23/09/25 FINAL DESIGN 23/10/27 DEVT PHASING PLAN 23/12/01 ISSUED FOR DEVELOPMENT PERMIT 24/01/07 SITE FORMATION 24/01/27 MAJOR SITE REVISION PER DP COMMENTS 24/02/01 REVISED PER SITE SURVEY (GRADES) UPDATE 24/02/08 UPDATE SITE SECTIONS 24/02/16 UPDATE SITE PLAN W/FIRE TRUCK PATH 24/03/03 ADD FIRE TRUCK TURNAROUND AND REDUCE SLOPES, REVISED SITE PLAN BLDGS 4, 5, 6 & 7, DELETE ONE UNIT 24/03/14 REVISED DRIVEWAYS, RET WALLS, ROAD SLOPES

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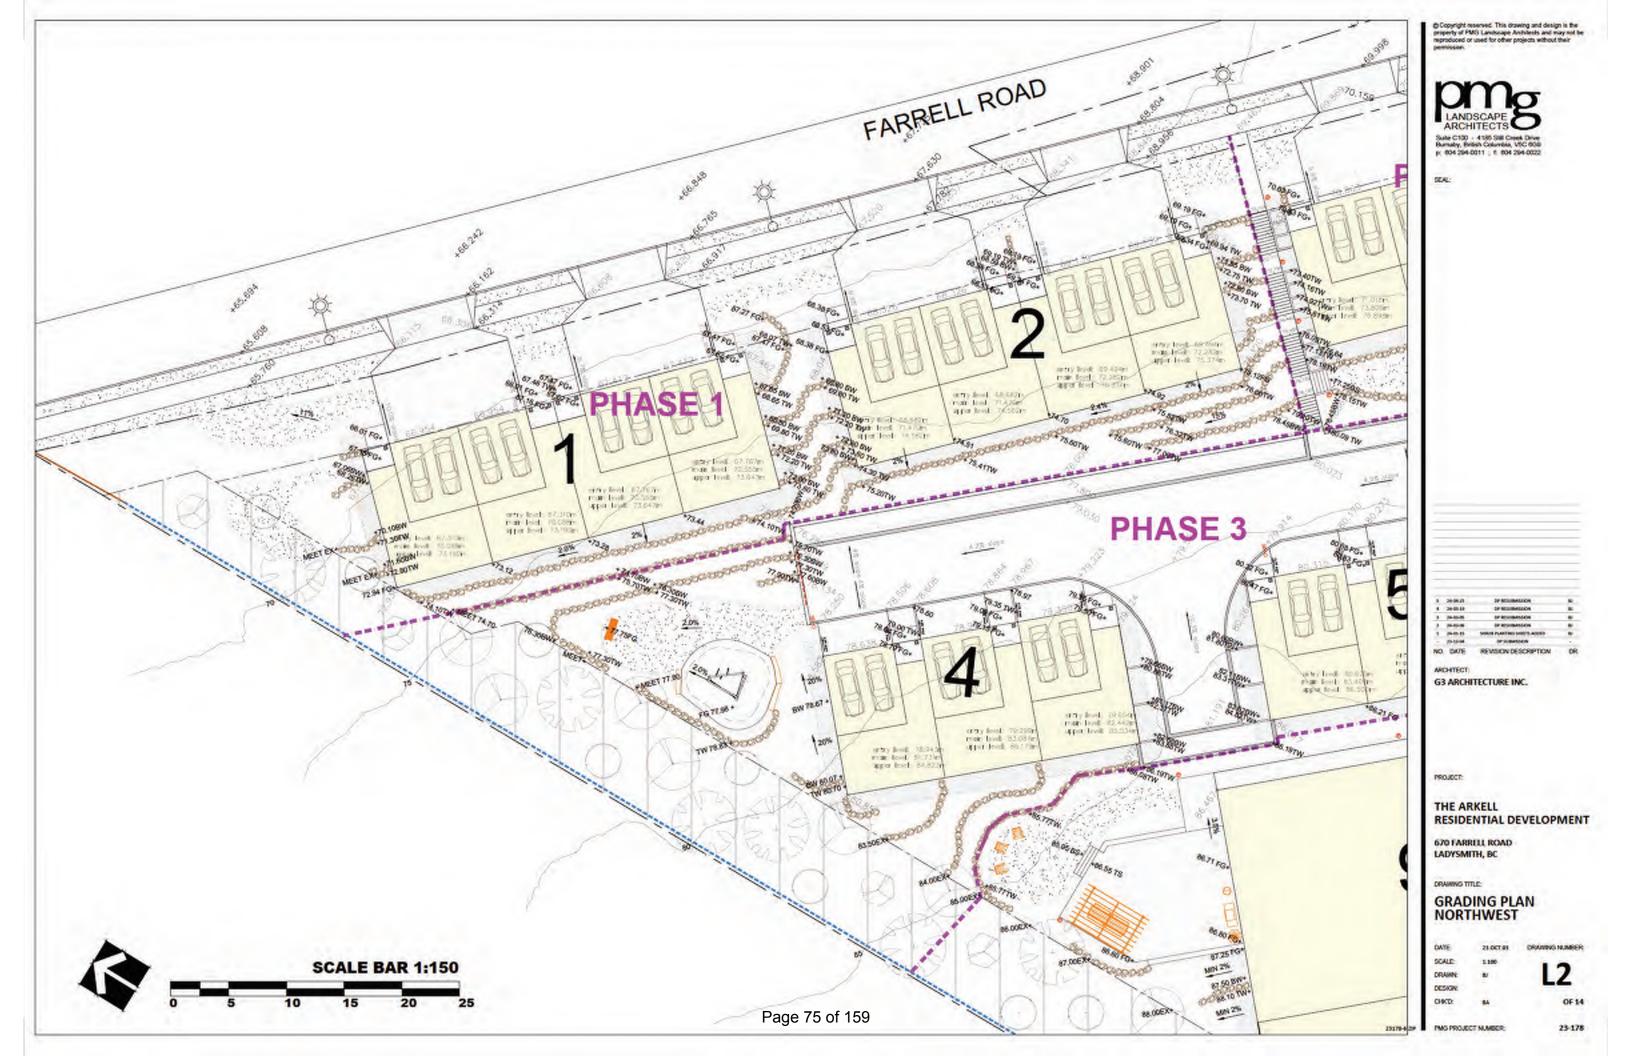
THE ARKELL RESIDENTIAL DEVELOPMENT 670 FARRELL ROAD LADYSMITH, BC


DEVELOPMENT PERMIT #DP22-14


TYPICAL EXTERIOR FINISHES TOWNHOUSES SCHEME C


SCALE DRAWING NO .: N.T.S. **DP530** 24/03/29







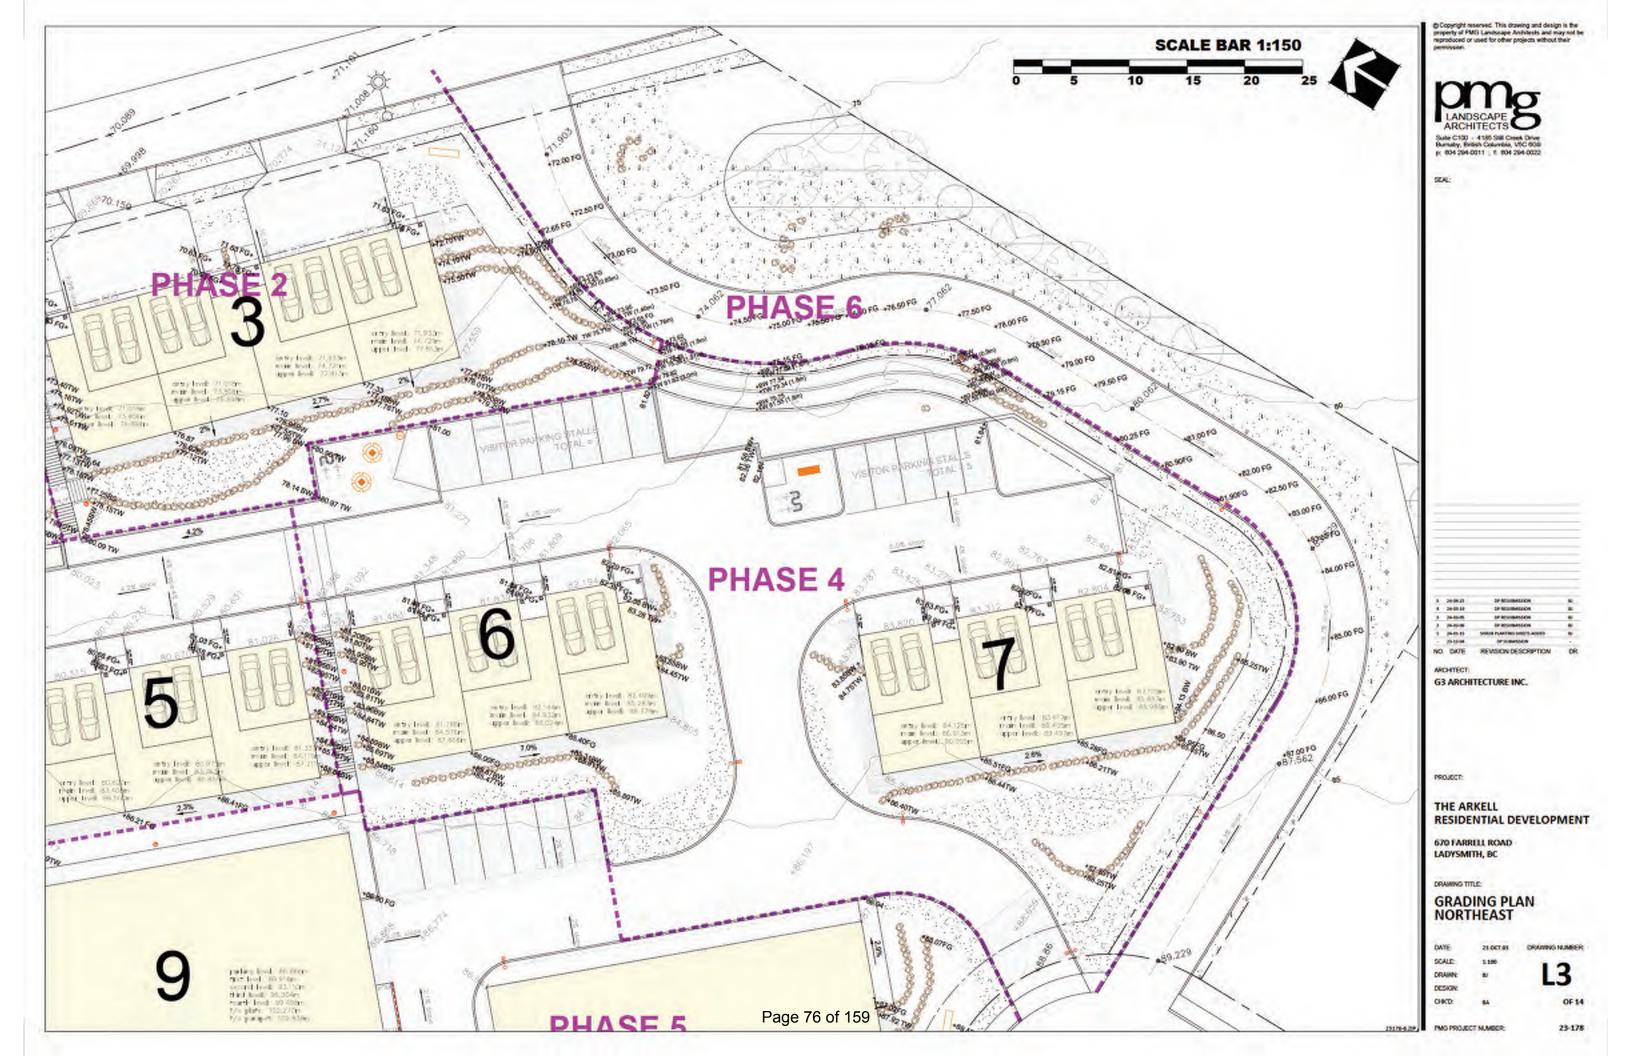

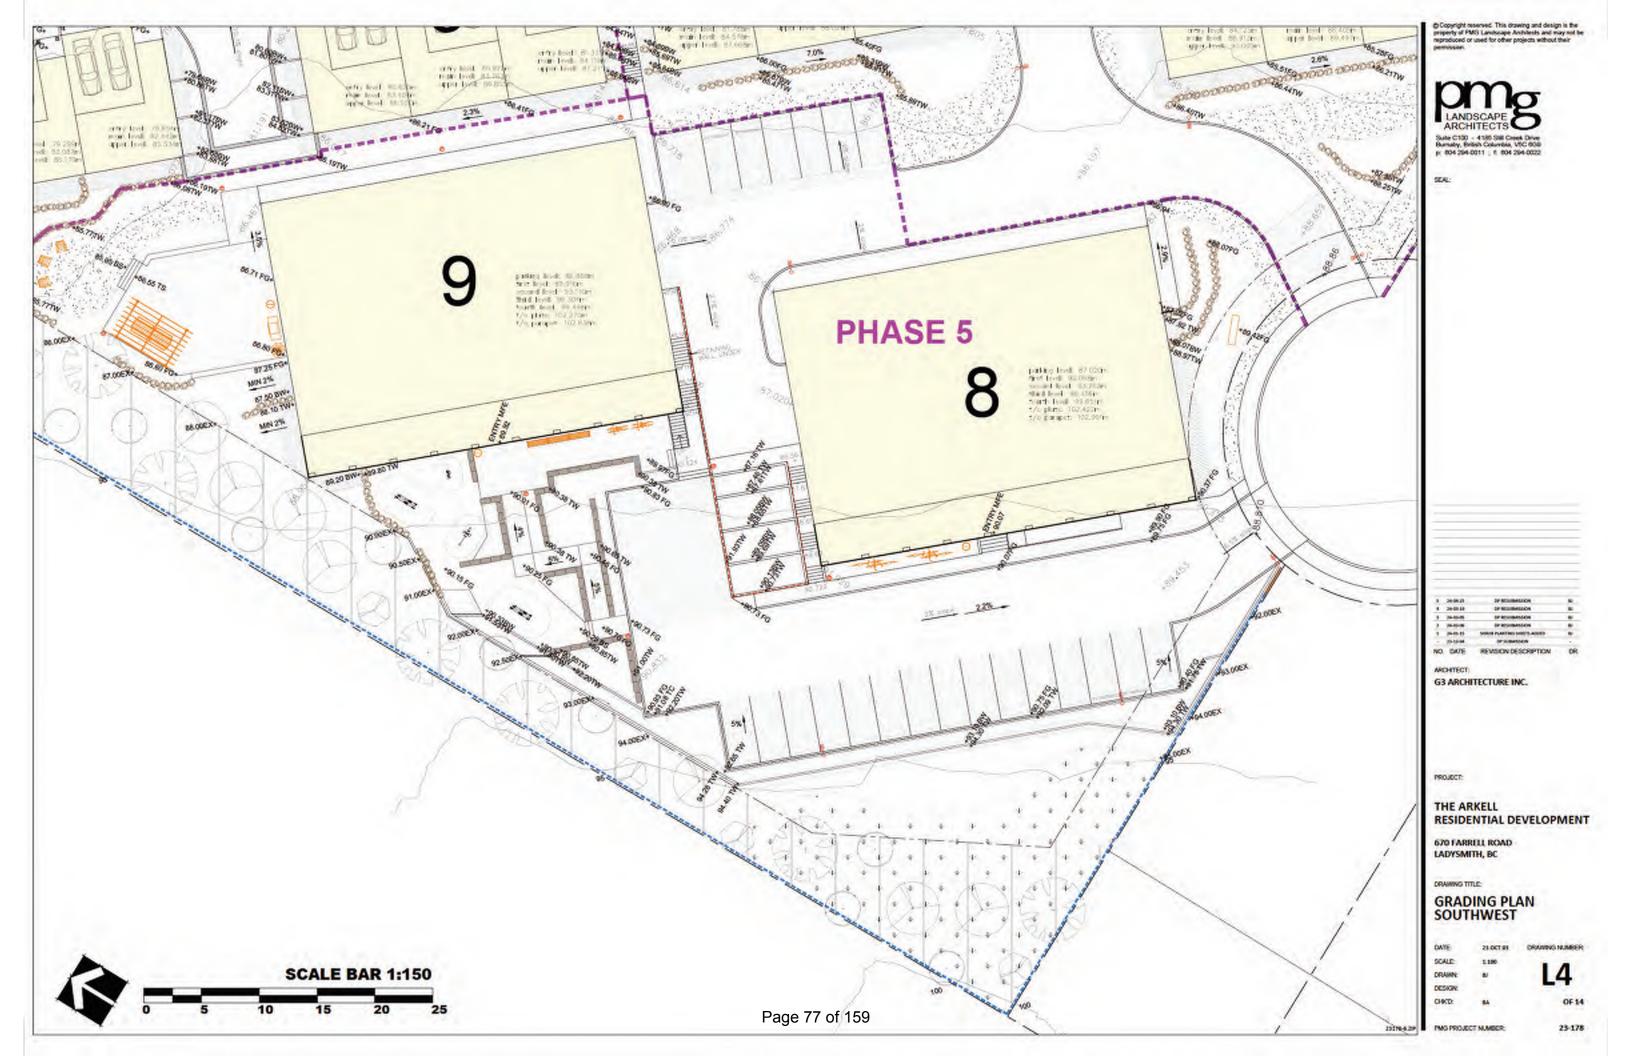

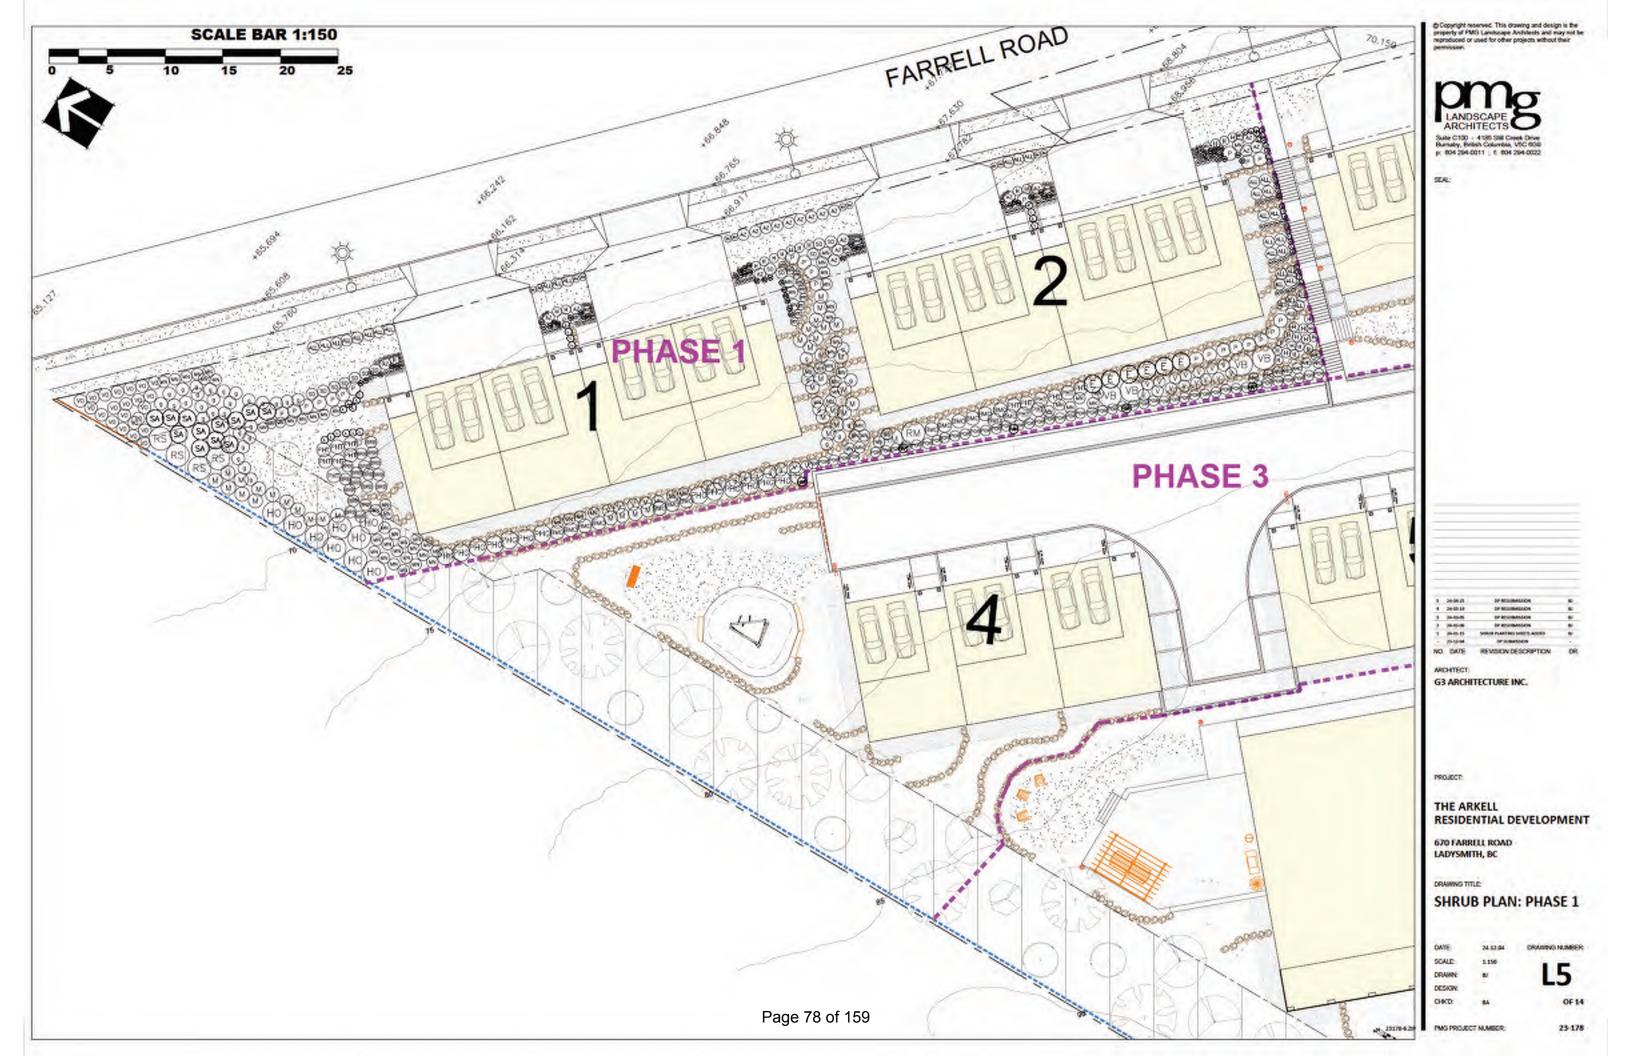

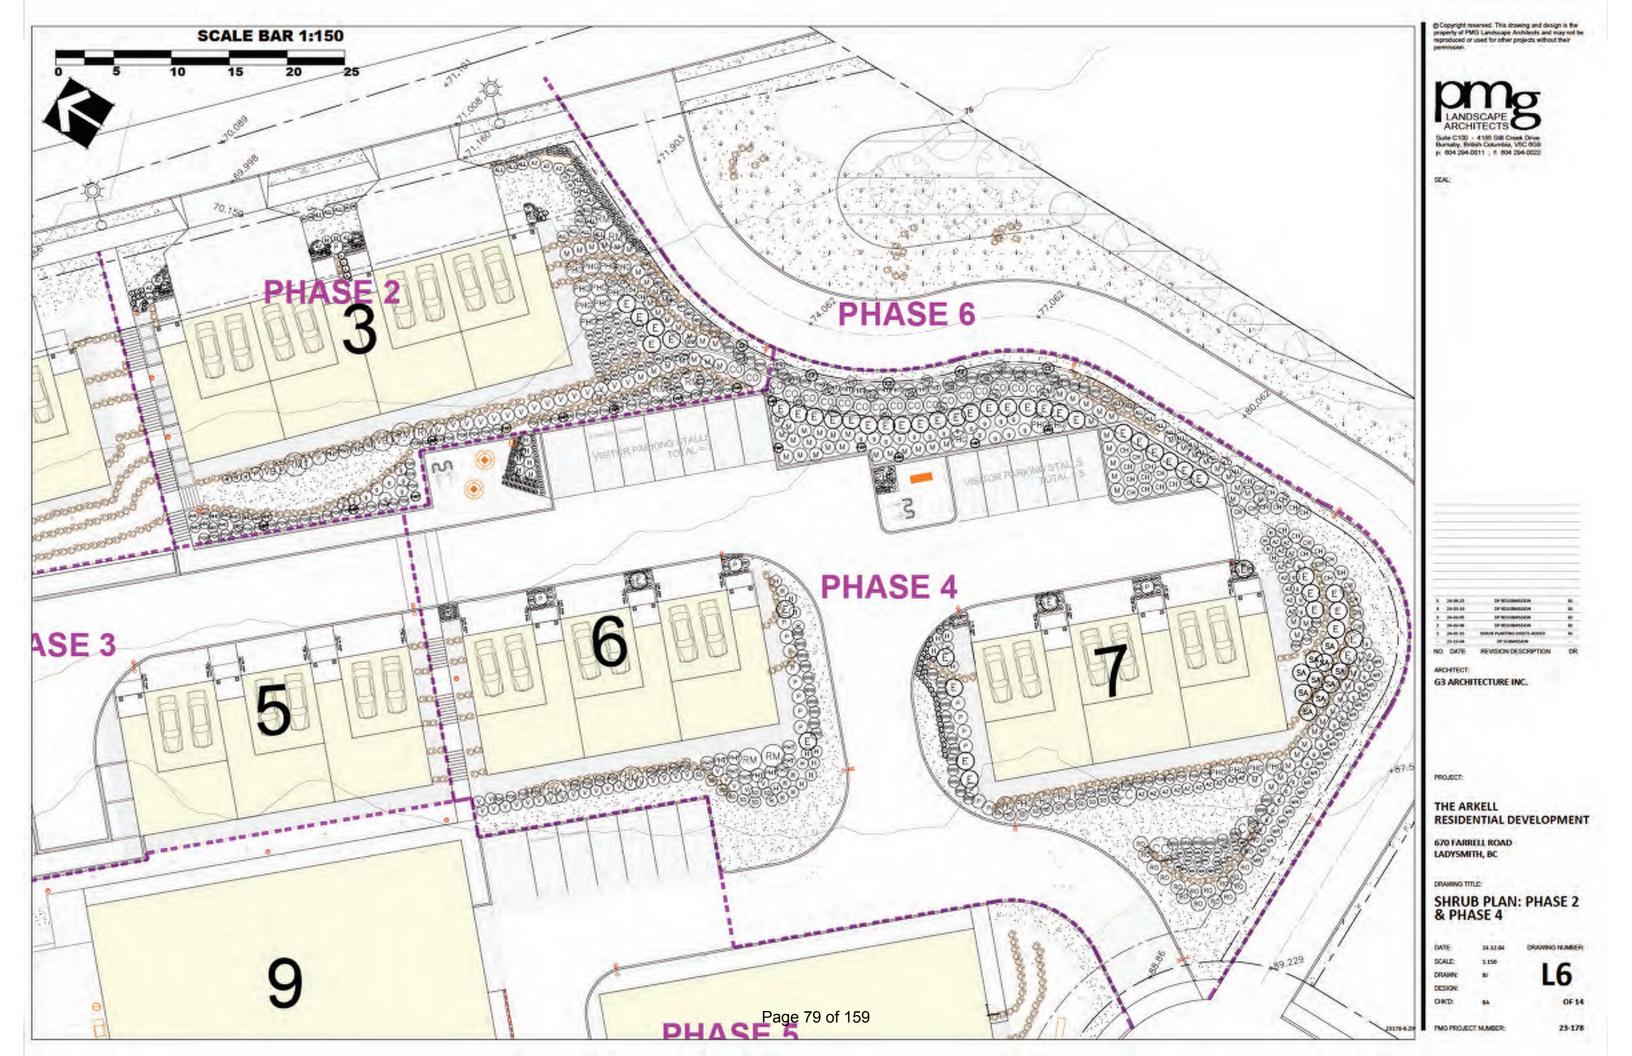

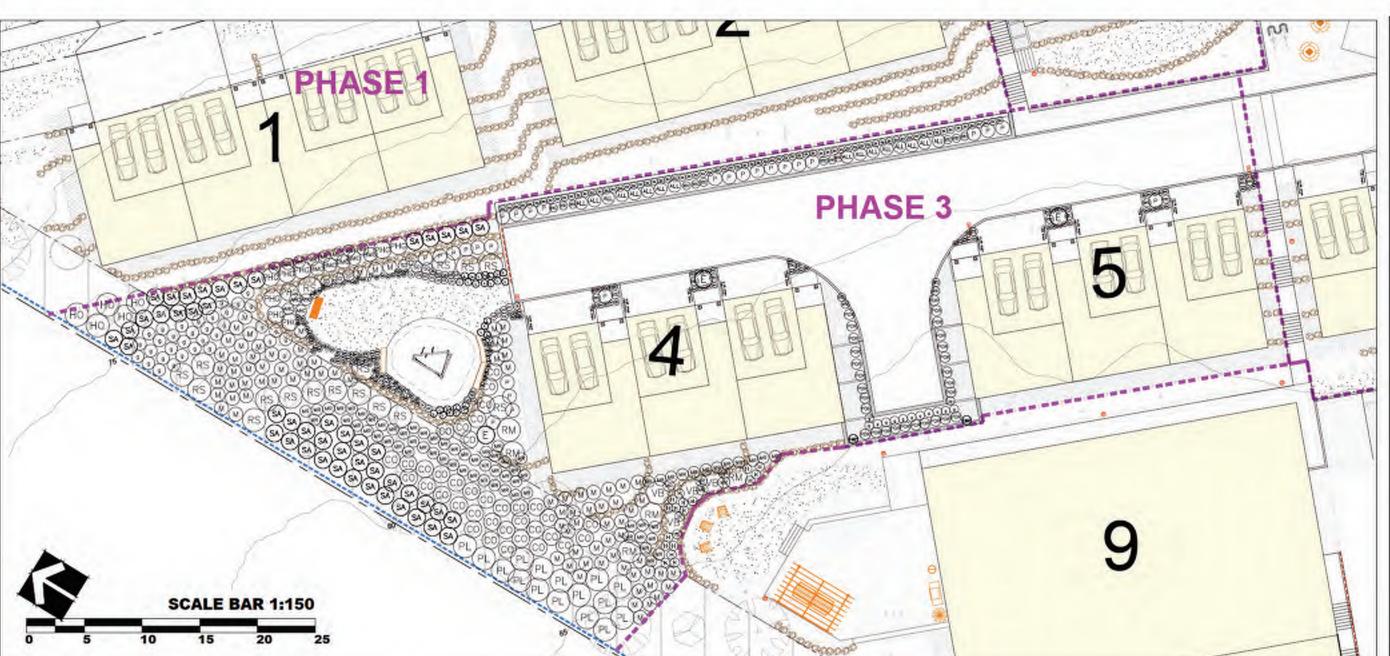

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NO.	DATE	REVISION DESCRIPTION	

G3 ARCHITECTURE INC.

PROJECT:

THE ARKELL RESIDENTIAL DEVELOPMENT


670 FARRELL ROAD LADYSMITH, BC


DRAWING TITLE:

**SHRUB PLAN: PHASE 3** 

DATE	24.12.04	DRAWING NUMBER
SCALE	1.150	
DRAWN:		17
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23-178



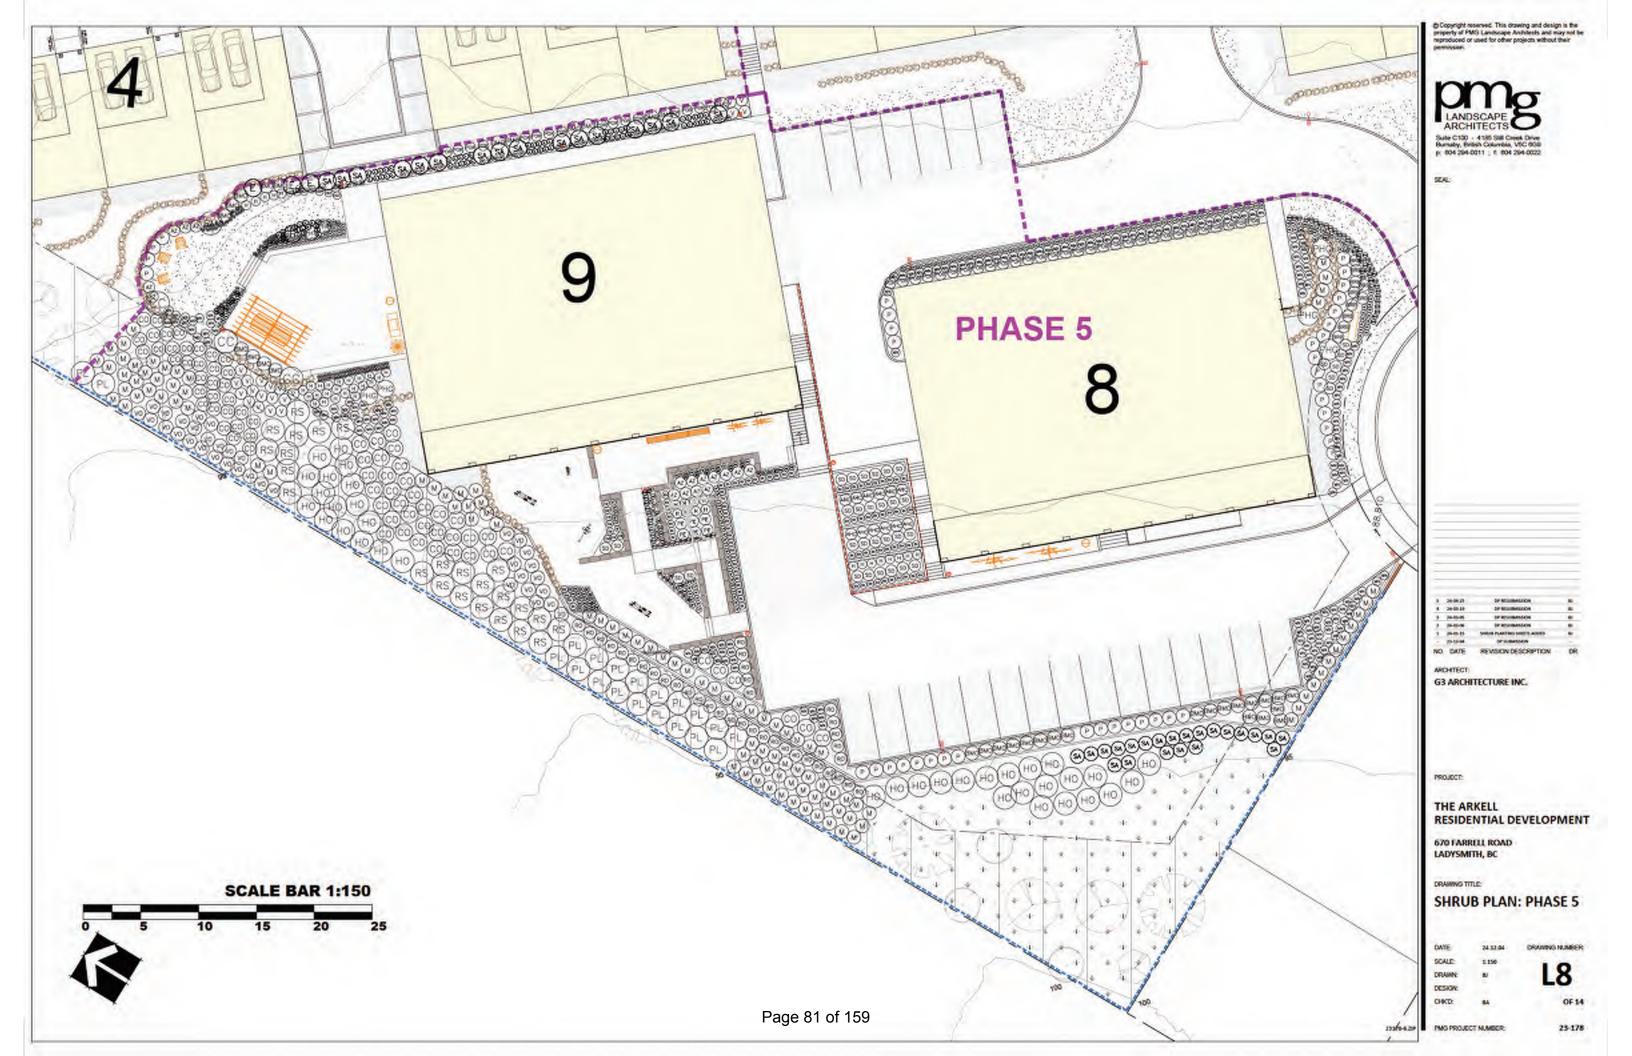
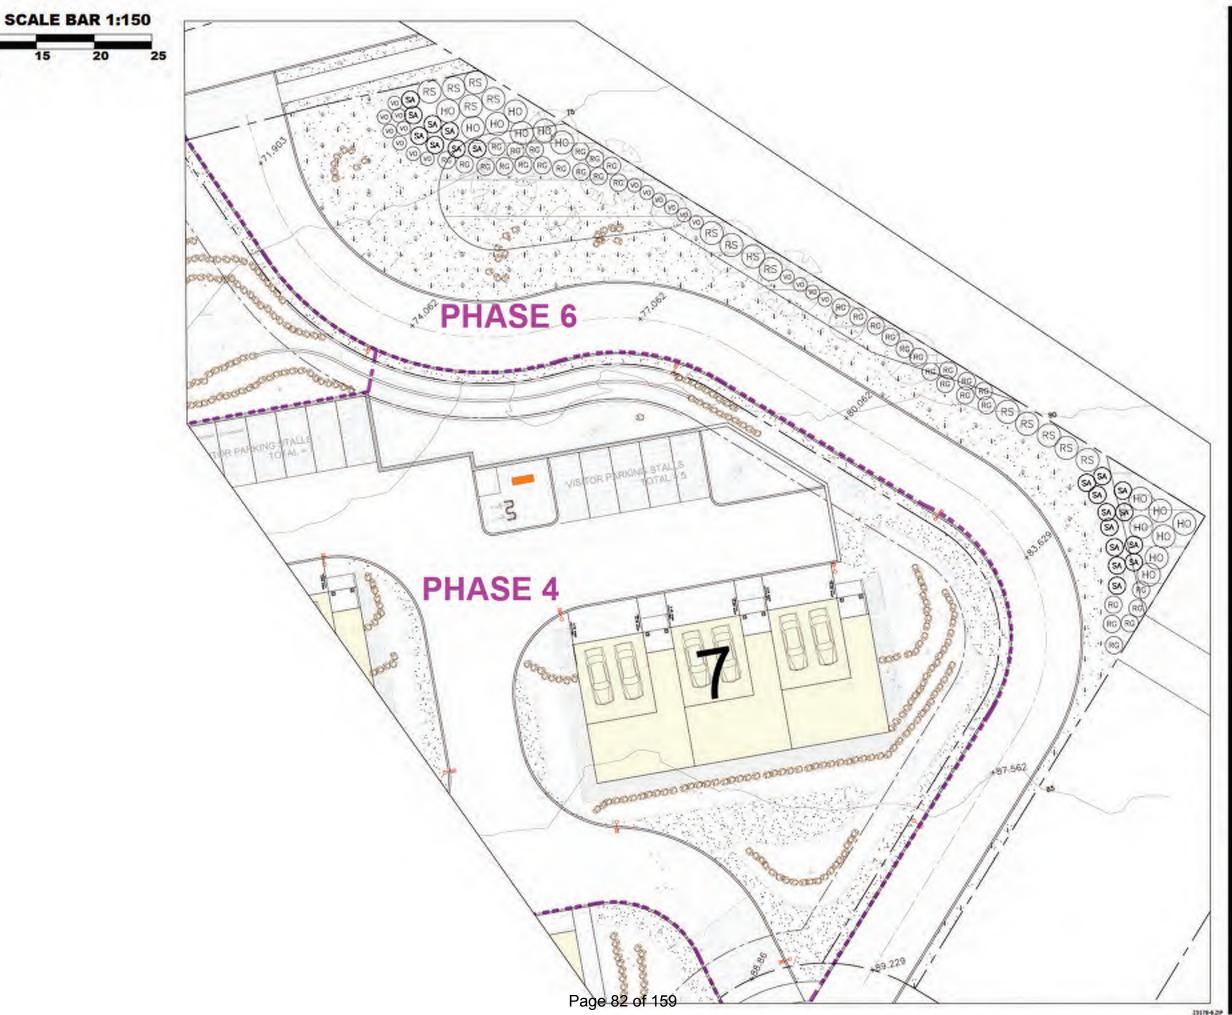
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G3 ARCHITECTURE INC.

PROJECT:

THE ARKELL
RESIDENTIAL DEVELOPMENT

670 FARRELL ROAD LADYSMITH, BC


DRAWING TITLE:

SHRUB PLAN: PHASE 6

DATE	24.12.04	DRAWING NUMBER
SCALE	1.150	
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19179-629 PMG PROJECT NUMBER:

23-178

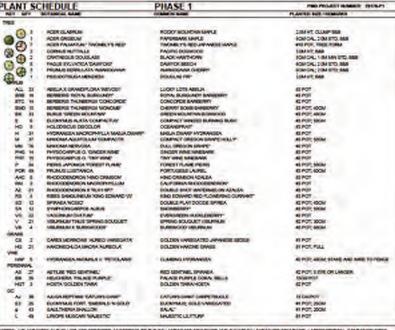

LANT	SCHEDULE	PHASE 1	PRO PROJECT INSMITE SECURE
NAT W	W BOTSHILL SAME	CORRECT SAME	PLANTED BUT PREMIUM
793			
-0	2 ROSTOLATION	RODOV NOLHENN MANUE	DIMPT CLIMPTON
20	1 ACER ORGEOW	PAPERBASK MAPLE	HOMOR, 2 OM 870, MM
W/7	2 NORTHWEST TWOMPYS NED	THE REST OF THE PROPERTY WAS IN	WILL PORT, TRUCK PORMA
0	2 COMMENTATIONAL	PAGING DOWNSOOD	SOMETH BAD
80	2 OWNERS COURSE	BLACKHANTHON	POWORL 1 MILES STD. 668
~ W	E PROJETY/ACCATAMONY	DANTOK BEECH	ACM CHL 2 DM STO, 868
13 m	1 PRIMER REPORT AND ADDRESS OF	PARTICIANA (VENET	STANSAS, STANSASS
A 15	T PRODUCTION AND ADDRESS OF	DOMESTIC TOP	URANT BAR
When .	1 Laminos and a second and a	produced ton	Hard of Sales
AL.	20 WIELAX OKWOPLONA WEVOOR	ELECTRICITE ARELIA	as Port
944	IN SERVICES TOTAL BURGLAST	ROPAL BURGLACT BARROWS	45 (10)
870	H BEFEERIN THUNBERGE CONCORDE	CONCOPCE BARRETORY	42 POT
mio	II BERBERG THUNERGE WONCOM!	CHEMOT BOXID SAMBLERRY	AS POT, 400M
	23 PLANT THE PROPERTY.	DATES NO. IN THE BUILDINGS IN	16 POP 400M
	6 DUMMARA MATATORPHIA	COMPACT SPRING BLENNIS BLEST	45 POR SNOW
140	E HOLDDOOLD DECOLOR	CCEASEPRAIT	61 POP
H	27 POSPANISA NACIOPATLIA MANA	SWARP MADA CHARP HYDRANDIA	SI POT
	P MINISTERNATION OF THE PARTY O	COMPACT ORGICON GROWTH HALF	AS POST SINIAL
Labora .	TO MANUFACTURE	DAY OFFICE STORY	40 POP
2040		CHICEY AME WAS ARK	60 POT
	TO PROTECTION OF THE WINE	TOY WAS SHEEDING	APRIL
	AL PERS APONGS TORREST DUSC	CONCETTS AND CREATE	WE PROFE SOCIAL
POR		PORTUGERE LAUPEL	KI POT, SOOM
AHO	I RHODODENONON NINO CHIMBON	HINDONINGH ADKEA	AS POT
1004	2 BROODSNOOS WORDSNAM	CALIFORNIA DECEMBRISHED	MI POR
- 22	21 RECOCKSONS CTURES	DOMEST AND	#1 PGF
100	4 REES SHOUNEUM YORK EDWARDS		ELPOT
	D SPRAGA NODEZ	DOUBLE PLAY DOCCE SPINEA	60 POT-400M
EA.	O PROPERSONNELLARIS	to outsiday	ALP OF SHIM
	All taking activities	CARRIAGES IN COLUMN	40 POP
	21 HIBURNANTHUS SPRINGSOUGUET	EPHING SOUGUET (SUPPLIE)	62 POT 300W
140	A SHARMAN A SAMOUR CONT.	BLEEN COLUMN STRANS	ALPER WOM
MAN	2 managed attributed	falling marks	- Common
	I CARES MORROWS HUNEO (MISSON)	N DOLDEN WARRINGTO APARETE REDGE	#I POT
	21 HAKINED-CAMPORA NURBICA	DOLDEN HANDNE DANCE	REPORTULE
VINE.		Parameter of the second	411-00-00
100	5 PERSONAL MEMBER & PETERSON	CARRO PERANTA	ALTER ADDRESSMENT AND MICE TO FORCE
PERMIT		The section of	Action of the Control
AL.	27 NUTLIE WID SERTING	RED SENTINEL SPINAGA	40 POT LINE OF LANCER
	IS RECEIVED THANK THEN	PACAGE PURPLE CORAL MILLS	received.
HIT	3 HORTA DOLDEN TARK	DOLDEN TARKA HOETA	82 POF
00			
	M AAGA REPTIME GATURE GIRKE	CATURE GREAT GREAT TRACKS	15 CHAPTER
18	25 BUDNING FORE THERMAL WOOL		et Púri; 25 list
	O GALLTHORASHADON	BAA"	#I POT, 200M
E.	49 LINOYE MUSCANI NAJESTIC	MARRIED CLUTTURE	ALPOT

CONTAMENSORS  THE CONTAMENS  DECAPE MONTECT AT  TIMES TO MANAGE  WHO FOR REQUEST TO  BUILTY ALLMSHEAMS	SPECIFICAL PRI CHA SPINCAVO, SICH Y REALIZABRITTANC CHIR PLANT METRO SOURCE OF SUPPLY, WISH OF SPINCATOS ANY SERTITUTORS TO THE SPECIFIC MOD BURSTITUTE, SUBSTITUTORS ARE SUBSTITUTED MATERIAL MOD MODIFICATION OF SPINCATORS OF MODIFICATION OF STREET OF STREET OF MODIFIED PRODUCTION OF STREET OF STREET OF MODIFIED PRODUCTION OF STREET OF STREET OF MODIFIED PRODUCTION OF STREET
EPLAL MUST GE	

PLANT S	CHEDULE	PHASE 2	PMI PROJECT NUMBER: 20176-2
May May	SATE ADDRESS TAKEN	STREETS WAST	PLANTIN SOLI BURANA
THE .	Carry Coll	CONTRACTOR AND A	A CONTRACTOR OF THE PARTY OF TH
CO 2	ACID GLADRIM	ROCKY MOUNTAIN NAPLE	ZIM 4T, CLIMP BAS
(4)=	ACES PRESENTEM TRICKBLY'S RECT	TACHBLY'S RED JAPANESIS MAYLE	BIS POR THEE PORM
~~	- ARRAPUS MONDERN	PROFFE SAMPONE"	2.004 (17, 2006)
000	COMMUNICATIVESS	PACIFIC DOGADOD	3.06 4T, 808
	CINITATIOUS DOUGLASS	BLACKHAWTHOPH	SON CAL, LIMININ STE, SIGS
(8)	DISOR BRANDISK SAMPRISK	BANTON BOECK	GONDON'S TRANSPER MAY
<b>EGI 8</b>	DOUG PLANTOL NO PROTECTION	ROMAN (MICLIOCAEDON	5,000 GA; 1,96500; BM
St.	PROJECT SERVICE AND SERVICE SE	MANOCANA CHEMION	GON CAL IDM STD BAD
MA. 18	ABBUILDBANDIFLORANDIOP	SUDOTURE MININA	AS POF
800 T	RESIDENS TIONA BUSINAST	NOTIN, BURGLINGY SHESSINY	40 POF
870 2	SEPREMIS THUMBERON CONCORDS:	CONCORDE BANDERVOY	AC POT
BX 36	BLOCK GREEN MOUNTAIN	DEEN MOUNTAIN BORNOOD	40 POT 400W
69 5	SORNUS SORGEA WASTES FIRE	MICHIE PRIE DOGONOCOP	10 POF
E E	ELIONYMUSIALATA COMPACTUE	COMPACT WINGED SURVING BUILD	AS POT ROOM
H III	PROTECTION OF THE AMERICAN PROPERTY OF THE PROTECTION OF THE PROTE	NAMA OWAYP HIDSHOPA	MI POT
N 25	NAMES AND POST OF THE PARTY OF	COMPACT ORGODIS STAPE HOLD!	100 POP 300W
APR 50	INVENIMENTAL.	BALL ORDOOM SHAPE	AC POR
PHG ID	PHYSOCARPUB O, 'DINDEN WINE'	GROSS WINE NIMEBANG	RI POT
PHT 6	PHYSICOMPUS O TRY WHET	TINT WHE WASHING	AC POT
	PRINCIPONICA FOREST FLAME	FOREST FLAME PIONS	AS POR SOCIAL
POR 42	PROPERTY AND PERSONS ASSESSED.	POPULATION LAKES	WE PUR WHITE
MC 21	RECOCCENERCH MINOCRARION	HING CHINDON ADALIA	AS FOT
856 F	RECEDENDACH BACKOPPHILLER	SAJPONNA/BIODODDIORON*	AS POP
42 7	SECRECIONALISMOS STATES OF THE PROPERTY OF T	DOUBLE BUILT WATERAGE DIS NOTA EA	43 POF
80 1	SPRAGA NODO	DOUBLE PLAY GOODS SPIRES.	KD POT 400H
W (88	VERDINGSTRUS SPEKS BOLOURT	SPRING SCUGUET VIBLIPHILM	40 POT. 300W
- 14 2	VIRGINAL STATEMENT OF	BURNOUS VINISHEM	NO POR WICH
BANK			
HQ 8	HAVENED-LOR MACAN ALREDLY	GOLDEN HAVONE GRADS	BI POT PULL
VINE			
EAR &	PERSONAL PRODUCTION OF THE PERSON OF T	G.MBNG IPPORTAGEA	40 POT 400K STAVE MICHAEL TO FEND
60 - 2	PROFESSIONAL PROLESSION ASSESSOR	BOSTON AT	NO PER WANTE STANDS
PERSONAL.			
44. 4.	VILLE JED SENENE.	RED SENTINES, SPHINES	40 POT 1 DY DRIVATION
1 20 194	HELGHERS WANTE PURPLE	PAINT NAME OFFICE BOAR	TOOM POP
HOT 3	HOSTN GOLDEN TANK	GOLDEN TAKAHOKTA	AC POP
00			
W P	ALIANDEWS GALMEGINE	CALMS COMT CARRETRIGLE	15 GAPOF
	SCHEMENETER HORIZOWINGS	ROCKBERGY GUTCHEADTER	ALPOY ASSAULT
HT 12	ERICA CAVARA VIVILLE	HEATH, SHORTY MED POLINGE:	#1 POT
10 7	ELICAYMUS PORT, BARRALD N GOLD	ELOWYNER, GOLD WARRENTED	#1 POT 200H
2 19	SAATIONA SPALON	SAA'	ALPOY DOOR
L 98	LINDYE MUNICANI MARKETO	MAJESTIC LLYTUPP	AL POT
107 26	NAVORA REPENS	CHESPING MAHORIK	#1 POT 200H

LANT S	CHEDULE	PHASE 3	PROPROGET MARKET STYLES
MET MIT	WITHOUT SAME	COMMON NAME.	PLANTED BOX - TERROPA
-	CROARIN		DIMENT CLASS SEE
		RODOY MOUNTHIN MAPLE	
W (2)	ACER GREEUW	PAPERBANKAHPLE	NOW DALL DOM STD. MAR
	CORRESPONDENCE	YASING BOOMBOD	TOMOT BAD
No.	FROM ENVIRONMENT DREAMS	POHAN OBELEK BEECH	EDOWCAL, LIMITED MAN
200	PRIELEOTRAGAMENZIERI	DOLGLAG PRE	LOW HT, MAS
San I	CHEMICAL SHIPPAN	CARRY CAP	SOM OF THE PARTY NAMED IN
AL IL	RELIAX GRANDIFLORA WENCEY	LUCKY LOTS ARELIA	REPORT.
BTC 28	REMIERS THUNERS CONCORDS	CONCERER SAMBLEWAY	60 POT
BIO 5	RETRIERIO PIRAMERICA MINICADI	OWNER BOND SAMBLERY	ME POP: ADDM
88 195	BURNS TORONG MOUNTAIN	GREEN MOUNT NO ROUNDOOD	WE POST ARRAY
00 B	CORNELS SERVICEA ARCTIC PIPET	ANCTIC FIRE DOGWOOD"	KI POT
2 3	BUCKNIAN ALATA COMPACTURE	COMPACT MINIORS BURNING BURN	85 POT SOOM
100 %	PERSONAL PROGRAM	CERNETON	MI POF
H 18	HYCHANDIA NACROPHYLLA MALLA DIVARP	MAGUA DISARF HYCHANGEA	60 POT
W DE	MHICHIA ADUPQUIAI GEMPACEK	COMPACT ORDINON OR AND HOLLY	REPORT SOOM
N 10	PURANCEPIER LEARNING	LEWIS MODROWAND	AS ALCO SOCIAL
Mar. 9	PHYSIOGRAPUS O, SUNGER WHAT	SPECIFICATION SPECIALS.	#1.POP
F 27	PERS APONCA POPERT PLANS	POREST IS AND PREMIS	WE POT HOOM
POR CE	PRUNUR LUBITARICA	POYTAGESE LAUREL	KE POT 400M
A10. 4	BIGGGGGAGNON NING DRIMBON	ARREST CARREST ASSESSMENT	86 PGF
der S	RECOGNOSION SACREPORT LAN	TALE BY A STREET, STREET	ment .
FID 17	KIRKS ENGUNEUM YORG EDWARD VIT	KING KOWNED HED PLONEPUNG CLARINOT!	60 POT
9 7	PRACANGER	DOLBLE MAY DOCKIE PRICA	NE POP, AND A
N 40	PROPERTY AND ADDRESS OF THE PERSON ADDRESS OF THE PERSON AND ADDRESS OF THE PERSON AND ADDRESS OF THE PERSON ADDRESS	WATEMETINY"	AND ROOM NAMED
V9 4	HISTORICAL STRUCKSOCK	BURROROCO VIBURRORI	KE POT 400M
DIADE			
OK 34	EMBLMORIOWS INDEO VINIBUISM	COLDEN SAMESATED ANYMORE BESIDE:	an trial
166 71	NAMED ROLLINGS AND STREET, AT	GOLDEN HAVENER SIGNER	art POST, Road,
/NE		A second	
HAP 2	PORMISE MODELA E PETICARE	GLABING PYCHANGES	SE POT, GOAL STAND AND ARRESTS FEMALE
GM S	CONCEPNEY MODRED ST	SANCHARIAN TURNICAN	et milit
HE 32	HEMEROCALLE TITELA DORD	ETILLA DORO DAVILLY	REPORT HORSE
66 17	RESIDENT TRACE PURPLE	PAINS PURPLE CORN, MILLS.	TO DE PROPE
	ALL DEPOSA	THE STATE OF THE SAME TY	MI PORT & SAME.
00			
4 47	SACKTHERSA SHAKLON	IAA*	#I POT: 300M
	LINESPE NAMED OF THE PROPERTY.	MARKELLETAR	#1 POP
100 10	LINE CALL PROPERTY.	CHESTANI MANCHAY	et POP 20004

NOT THAT IS NOT A STORE ROUSE CONTROL OF THE CASE OF T

LANT S	CHEDULE	PHASE 4	PMO/PROJECT MUNICIPAL CHIEF
PEY STY	SCHARCAL WARE	COMMON HAME	PLANTED ROLL WEBARDS
THE	Law was	THE RESERVE TO SERVE	
~ (i)	NORTH SUMMAN	ROGOTHOLIUNAMENTA	ZOLATY GLANPING
	ACER GREEN.NE	PAPERSANG MAPLE	SONE PROPERTY AND COLUMN
- 100 t	APPLITUD MENCHERS	PACIFIC MACRONET	IOM NT. BEA
20 000	FROM BY, VATION BARYON	EARTON MEDIA	BONDY, 21M 810, 668.
- C -	Labrie BATALLIN AGIANA GORDINA.	BOWAY CORP. ON MODELS	SHOWGAL LINESTER MAN
B	PINCE CONTONTA	B-CPE-PMC	ZIMANT, BAD
T (19)	PHLINOS SETULLATA MARKOGRAK	AMHOCAVA.O-ERROT	BON-OHL, 2 OM STO, BEST
30.00	PREJOCHNOLMINZER	DOLGENS PRO	TOWN SAN
	SOURCE PROPERTY SHOWS	CAMERAL ROYAL SOLMERS AND	ROW-DAT SAN BASK ARE.
AL II	HELIA KORWIDITUGRA WEVGET	LUCKY LOTS ABILIA	ELPOT
\$400 St.	BERBERS REVA BURGLARY	ROYA, BURGUNOT BARRORET	#5 PGP
BTC 96	REPRESENT THE MERCH CONCORDS:	CONCORDE BARBERRY	REPORT
EX di	BUXUS SPEEN WOLNTAW	CREEN WOLKENIA BOWNOOD	REPORT HOOM
68 %	CORNAIS RETRICKS WHITTIGHTED	WIGHE THE BOOMODO!	ME POT
06 1	DOTWING DOGGROUN SOYN, PLANTS	PLANTA MADE BLOK	TARREST, SANS, IN STREET,
E 41	ELCMANUS HEATA COMPACTUE	COMPACT WINGSED BURNING BUSIN	KE POT, IDOM
H 33	POTRANSIA NACROPHYLIA MALIADINARY	MAGUA DINASE MORANDEA	REPOR
4 9	MARCHIA AGUNG AM GOMPAGOY	COMPACT ORGOOD GAPS HOLLY	WE PROTE SOCIAL
Late 113	September 1987 Contract Contra	DALORDON DOWN	na Prof.
MHD C	PHYSIOCHRAIS O, GRIGER WHIE	CONDEX ARE NIMEDARK	#SPOT
PC 3	PHYSIOCHRUS O, TRY WINE	TINY WINE NINEBASK	G POT
	PERSONAL POREST FUNET	POREST DAME PERSON	REPORT SHOW
POR 20	PRUMUS UUSITANDA	PORTLOGER LAURES.	REPORT BOOM
A40 1	RECOCCURERON NAVO CRIMINON	HIND CRIMICH ACKER	ELECT
1992 - 4	RECOGNISION INCOMPOSALINE	EALFORNA INCOMENSATION	81 POF
W 30	BE00000000130197	DOMESTICS ANTENNOON OLAND	#1 POP
RD 17	ROBATICARLIT MEDILARD	DOMEST MEDICAG FORE	BARCE
80 19	SPINAGA NOSICI	DOMBUS PLAY DOCCE SPIREA	ME POT HOOM
M 18	PARTERIOR AND ADDRESS OF THE PARTER AND ADDR	DIN PARKETY	WE POST SOCIAL
V 26	MILENIAN TIME SPRING BOLGLET	SPENS SCHOOL TOWNSHIP	as well balan
DIAME	minute men butter annual.	Parameter Landson	ALTON MAN
- 64 4	CAREC MORROWS AND DO VANDESMON.	SELECT SAMESATES ANALYSIS SOUR	#1 FGF
165 30	PARTICIPATION NAMED AS	DELETA PASSINE DIAME	MI POP. PLAA.
800 ZI	HELICTUTROHON SEMPERAMENS	BLUE OFF GRADE	RI POT, PULL
OME .	A CONTRACTOR OF THE PARTY OF TH		
100F S.	MORANICA MICANA V. PETRILAND	GLASSIG INTRAVISA	NETSER ADDRESSMENT AND MAKE TO FEM.
P9 17	PARTICIPACIONE O THE APPEARS VETERING	900709 NT	ME POP: ADDRESS NOWSKED
PERSONA			
HE SE	HENEROOKLIS STELLADORO*	STELLADORO DAVLY	MINOR HORAN
86 37	PERSONAL PRINCIPAL PRINCIP	PAINT PURPLE CORN, SELLA	TROWNS
90	Table Committee	110000100000000000000000000000000000000	1000
A 28	COTONEASTER HORIZONTALIE	RODISPRAY COTTON ENGTER	REPORT HIGH
89. 4	DESCRIPTION THERSDAY GOLD	EVENTAUR GOLDANIEGATED	91 POP: 250A4
2 41	SALTHING HALLIN	MA*	BY POST 200M
1 3	LINOYE MARCAN WARREDO'	MARKINGGENTURF	RIPOT
100 21	IAHONA/EPENS	CHEFFIG MACHA!	WI POT SOON

	CHEDULE	PHASE 5	PMO PROJECT HUMBER: SECTIFE
	SCHOOL WAS	COMMON WARE	PUNITED SEX HEMORE
THE REAL PROPERTY.	AGRICAN	PARTIE WAS INCOME.	MARKA SHIPTO HIS
400			
War.	AMERICAN MENCEUM	UVOLIC PROJECTS.	2,04147,066
C 25	COMMUNICATIVALIS	MACIFIC GOOMGOD	334 PT 868
200	VALUE BLEIKHOV (WWW.CR).	GAMAGE BESSOR	EDITOR, 23M/FD, WAR
400	NAME OF THE PROPERTY OF THE PARTY OF THE PAR	ROWCORD, DK REEDI	COLUMN CONTRACTOR
William .	GLEDTHAT NERHE SLEGGLE	BUMBURET HONEY LOCUET	NOM CALL LINETTO, BIRL EPPEARN
- III	PHUE CONTONTA	SHOKE FINE"	2.84 PT. 948
COLD.	PRESCRIPTION AND ADDRESS OF THE PRESCRIPTION ADDRESS OF THE PRESCRIPTION AND ADDRESS OF THE PRESCRIPTION AND ADDRESS OF THE PRESCRIPTION AND ADDRESS OF THE PRESCRIPTION ADDRESS OF	DOUGLAS FIRE	Index extraors
A 100 A	QUEROUS SARRYMA.	Graduit GWS	2,941/5,946
SZ	SOMBLE ALCOHOLY CANDING MOVIE:	CHIDINE ROTH MOUNTAINABH	HOM-CAL, 23N ETO, BISS
BEAR NO.	BESSERIS SCYN, BURGLINEY	REPORT BURGLAST BARBORY	AD PORT
BMC- 34	BERBERG THURBURGH WORKER	CHERWY SCALE SAVESTORY	ACROS ACCAS
86 90	BUILD CARTA REDUKTAN	CREEN MOUNTAINSCHOOL	ADMOT, ADMA
-60 19	CORNUS SERGES MICRO FINE	WHERE THE DOGWOOD!	<b>ADJPOT</b>
40 1	GETMAN CONGRESSION FORM, PARTY	CARDIE SHORE BASIN	SOMETHAM, INSTEAD
E 4	EUDPMUS AUTY COMPACTUE	COMPACT WINGSE GUINNING GUIN	IDIPOT IDIM
NO N	HISLODISCUS DISCOLOR	OCKNOWNY	70408
10 48	INTERMOCEANISCONFILM WAS ADMIT	MALIA OWNER INTERMICES.	#Schill.
N 167	MANUAL NUMBER AND DESCRIPTION	COMPANY DRESINGSAME HOUR	MODIF SHALL
864 175	MAKIMA MEMODIA	DULL CHROCH CHAPE?	10HOT
FL 20	PHEADRUPHUS LEWEST	CEMB MOCHCHANGE,	FOR TOTAL
200 E	PATROLANGE SINCER WINE	CANCER WHIE SHEEKING	#0.050E
MT 2	PHISOCAPPLE C. TRY WINE	THO' AINS HIMEBANK	KI POT
W 40	PIUNE APONCA PONEIT /S.AHE	POREST PLANE PRENS	ACHOE ACKN
POR 46	PRINCIPLE LUGITANIA	POWERANCE LANGE.	ACCOUNT SDEAL
A60 10	WOODDONGS AND DESIGN	HEND GERMANIA ANALIA	<b>PERFOR</b>
794 I	INVOCACING MACHON MACHON PARTIES	CHUPORNIA RHODODERDRON	SPCT .
AE 16	RHOCCORNOR & WARRINGT	DOUBLE SHOT WATERWELDMACKER	RPCT .
80 14	THE SANGANDAY THE COMMON!	NAME OF TAXABLE AND ADDRESS OF TAXABLE AND AD	#5.P07
90 17	MINA SCARLET MEDILAND	SURFICE MEDITATION	MAPS .
40 M	SPIRATA NOSC	DOUBLE PLAY DOCCIE SPINEA	EPCE 6004
65 16	PERSONAL PROPERTY.	Grant Note: Section of the Section o	SCHOOL SHIM
W 16	VACCINEMENTAL	EVENOMEN STUDIES CONTRACTOR	ACPUT .
V 20	VIDENTAL TIME TIMES EQUIPMENT	SPRING BOJOURT VIDURALIN	CPCT XXXX
GRAGE .	ARCHARG INCO INVIDENCE CONTROL	State of Sta	NOT-01, 0000
15 10	CALMAGREETE & NAV. FORWITH	NAME PORTROTTON PROGRAMMENT GRAMM	MORE TALL
100			
+6 C	CARD CHORDING ARREST VANDARA	COLORANDONIO NAMED 16066	PURCE
	HAROREO-LEANACRA NURBOLA:	COLDEN HAKIONE ORNES	MINOR PULL
900 41	HELICTOTRICHEN SEMPEN/PENS	BUJE CAT GRADS	MINOCHUL.
N 4	PERMISETUM RETACEUM TRUBULAY	PURPLE POLICIPANI GRAND	METER PAR
PERSONAL.	Course Story	Activities and all	Section Committee Committee
AB D	ALTERS HECHENTING	PRECIDENTIAL SPIRALA	SCHOOL SINE ON LANGER
6M 6	GUREOPSIE II. MODINESMP	MODRADIM TICKBEE	MINOR.
M 40	HOMEROGALIS STELLA PORD	STRUATIONS BASAT	MITTER TO COM
30 M	HELICHERA THLACE PURPLE	PALACE PURPLE CORNEL BELLS	INCM PCT
HET 10	HOSTA GOLDEN THANK	GOLDEN TANA HOSTA	REPOT
46			
GP 31	GALTIERA PROGUNEENS	SAME AND PARTY A	PROPERTY
- 44	LINCOPE MUSCARD MALESTIC	MARKETCULYTURF	ALCOHOL:

	CHEDULE	PHASE 6: OFF SITE	PHIS PROJECT NUMBER: 20178-00
NEY ON	BOTHHOA NAME	COMMON MARK	POWTED SEE! HEMOPS
B	ARRATIONNESSE	PROFESIONE	J. Sharef, State
	SARROLE GARRANA	SANTON	2 the of the
80 16	HOLDERSLE ORDOLOG	DODANISM	AS POP
66 Tak	RESES SANGLINELAN YORK (STANGED SEY.	SNE TOWARDER OF OWERING CURRON?	40 707
16 30	WORN DYMNOCHRINA	BHLDHF ROSE"	AC POT 400W
SA 20	STREPHORICARPOS ALBUS	INCASEMY*	40 POT BOOM
100' 16	VINDONAM OVIETOM"	ENERGHEDAL CONTRIBUTE	AR POP
10 16	VIOLENT CHILDRE		MINIT

PLANT SC	HEDULE	WINDOW
761	POD TIPE	DESCRIPTION
	positions	GRADE A ROSE CHARLE SHADE TO SERVEY WHISTY
	DROUGHT TOURNET ORALD S MAD SOMETHIN	HONORESCO SKYNE GRASS AND ALDILORES MIS FOR SUN-TSO



MICHITECT

PROJECT:

THE ARKELL
RESIDENTIAL DEVELOPMENT

670 FARRELL ROAD LADYSMITH, BC

G3 ARCHITECTURE INC.

DRAHING TITLE:

PLANT LISTS

DESIGN CHRCD

Page 83 of 159

MAT	MATERIALS LEGEND: PAVING						
	SWATCH	пем	DESCRIPTION				
		BF CONCRETE CONCRETE UNIT PAVERS CONCRETE UNIT PAVERS TERRACE & WALKWAYS PLAY SURFACING	DRIVEWAY APRONS, FRONT ENTRY PAVING, SIDEWALKS COLOURS: NATURAL PARKING STALLS: PERMEABLE PAVERS: MUTUAL MATERIALS ECOPRIORA PAVER 2000SX16CM COLOURS: CHARCOM, OR GREY (SEE PLAN), PATTERN RUNNING BOND TURNING DRIVEWAY: PERMEABLE PAVERS: MUTUAL MATERIALS HOLLAND PAVER EXCENSION COLOURS: CHARCOM, PATTERN HERENGIONE AMENITY PATTO: BROOMWY BOODSOCKOSTOM SLADS, ROMEVSAND SETTING COLOURS: HATURAL POURED IN PLACE RUBBER SURFACING, THICKNESS TO CSA REQUIREMENTS FOR PLAY PIECES COLOURS TED				

YM8CL	ITEM	DESCRIPTION
	DENCH	MAGLIN 'GONIC' 6'-0" BENCH, IPE WOOD WITH WHITE PC METAL FINISH
	BENCH - BACKLESS	MAGLIN 100NIC 6'-0" BACKLESS BENCH, IPE WOOD WITH WHITE PC METAL FINISH
-	EIKE RACK	MAGLIN TOONIC WHITE PO METAL FINISH
3	BIXE RACK	DERO "HI ROLLER' BIXE RACK FOR 4 BIXES - BLACK PC - INSROUND MOUNT
	PICNIC TABLE AND BENCHES	MAGLIN 100NIC 6'-0" TABLE AND BENCHES, IPE WOOD WITH WHITE PC METAL FINISH
TO STATE OF THE ST	ADRIONDACK CHAIR	MAGLIN 720' CHAIR - POWDERCOAT COLOURS TRO
0	WASTE RECEPTABLE	MAGLIN 250' WASTE RECEPTABLE, BLACK PO FINISH
	CONCRETE GAMES TABLE	SANDERSON CONCRETE - NATURAL COLOUR WITH CHECKERS GAMES INSERT
8	PLAY STRUCTURE	KOMPAN PARKOURZ' NR0852
	68Q LOCATION (BY STRATA)	PROVIDE GASIELECTRICAL HOOKUP
	WATER HOSE BID	PROVIDE WATER HOOKUP
1	BOULDERS	24-48" DIA NATURAL BOULDERS, ROUNDED EDGES, MAX 1000mm EXPOSED HEIGHT
4.	OUTDOOR EXERCISE - HIP	NORWELL 204
-	OUTDOOR EXERCISE - LDG	NORWELL 106
***	OUTDOOR EXERCISE - ELLIPTICAL	NORWELL 202

SYMBOL	ITEM	DESCRIPTION
8	ALUMINUM RAIL FENCE & GATE  1.8M ALUMINUM PERIMETER FENCE  GUARD RAIL/RAIL/NGS	DETAIL 1/L12 DETAIL 2/L12 PER ARCH, GUARD RAIL

MATERIALS LEGEND: LIGHTING						
SYMBOL	ITEM	DESCRIPTION				
0-00 P	STREET POLE LIGHT PEDESTRIAN POLE LIGHT	STRUCTURA WILA: 10' AND 30' HEIGHT: LED; DARK SKY COMPLIANT				



#### PROPOSED SITE ELEMENTS





MAGLIN TOONIC BIKE RACK





MAGLIN 100HIO PIONIC TABLE AND BACKLESS BENCHES



MAGLIN '25' WASTE RECEPTAGLE

POURED IN PLACE RUBBER SURFACING.

VARIOUS COLOURS



ALUMINUM FENCING



DERO WIROLLER BINE RACK FOR 24 BIKES



KOMPAN ROBINIA NR0852: "PARKOURZ"





NORWELL 202 - ELLIPTICAL/CROSS



NORWELL 204 - HIP

NORWELL 108 - LEG

DOULDERS AND DROUGHT TOLERANT PLANTINGS



STRUCTURA YILA POLE LIGHTS
117 HEIGHT
(TO BE CONFIRMED BY PROJECT
LIGHTING CONSULTANT

#### PROPOSED TREES



ACER GLABRUM



ACER PALMATUM TWOMBLEY'S RED SENTINEL











QUERCUS GARRYANA



SORBUS A. CARDINAL ROYAL'



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GLEDITSIA I. 'SUNCOLE'

PROJECT:

ARCHITECT

G3 ARCHITECTURE INC.

THE ARKELL RESIDENTIAL DEVELOPMENT


670 FARRELL ROAD LADYSMITH, BC

### LANDSCAPE DETAILS

DATE	23.007.03	DRAWING NUMBER
SCALE:	AS MOTEO	
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DESION		
CHACO	BA	OF 14

23-178

Page 84 of 159 19179-6239 PMG PROJECT NUMBER:

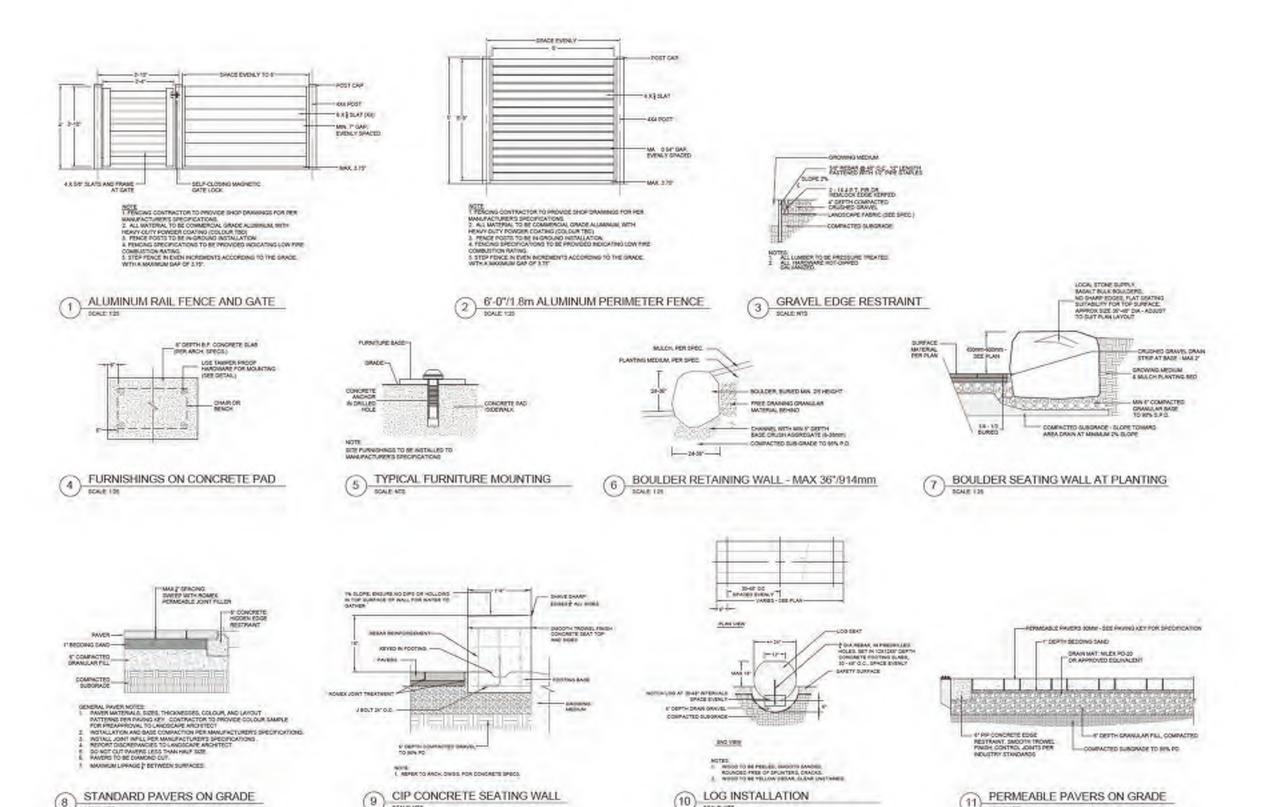

SCALE NTS

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ARCHITECTS

Suite C100 - 4195 Still Creek Dilue Burnally, British Columbia, VSC 908 p: 804 294 0011 | 6 804 294 0022

34-98-25 REVISION DESCRIPTION

ARCHITECT G3 ARCHITECTURE INC.

PROJECT:

THE ARKELL RESIDENTIAL DEVELOPMENT


**670 FARRELL ROAD** LADYSMITH, BC

#### LANDSCAPE DETAILS

23-007.03 SOALE AS-NOTES DRAIIN: DESIGN: CHICDS OF 14

23-178

SCALE NTS

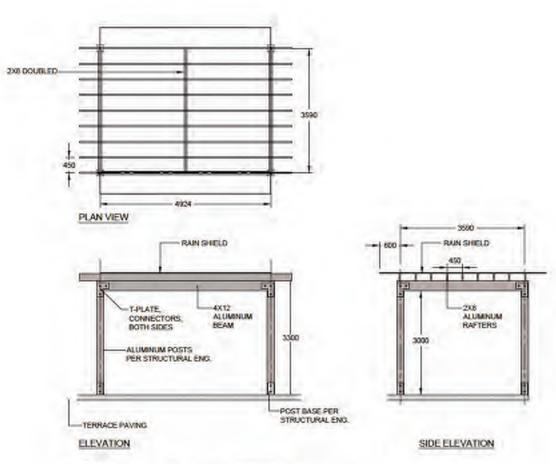

#### NOTES:

- 1. CONCEPT DRAWING: CONTRACTOR TO PROVIDE SHOP DRAWINGS FOR
- REVIEW BY LANDSCAPE ARCHITECT AND PROJECT STRUCTURAL ENGINEER: 2. ALL ALUMINUM TO BE COMMERCIAL GRADE AND HEAVY-DUTY.
- FOWDERCOATED, COLOUR TBD
- 3. FOOTINGS AND ATTACHMENTS TO BE COORDINATED WITH AND REVIEWED
- BY STRUCTURAL ENGINEER.

  4. RAIN SHIELD TO BE SHATTERPROOF.
- ARBOUR CONCEPT

MOTEG PROTECT TREE FROM DAMAGE CURRING PLANTING, TREE ROOTS NOT TO SE EXPOSED. TO SUR, FROST, MINE, DO NOT LET ROOTS ORY OUT. CONFIRM FREE DRAMING SUBSOIL. PROVIDE POSITIVE SURFACE DRAMINGS AT MINIMUM 2%. CONFIRM EXISTING GROWING MEGIUM MEETS SPECIFICATIONS AND IS SUITABLE FOR RE-USE. FERTILIZE AS PER GROWING MEDIUM TEST RESULTS. TO EXCEVATION ALL PLANTING INTO SHALL BE DUD. OF HAND WHERE UNDERGOODED SERVICES MAY EXIST. PROPERTY OF TOWOR SET THEE PLANE, USE TWO HOLING STAKES (SOME-TISHIN DA. P.T. WOOD), 20M IN LENGTH, EACH SET 10NS HT, 6ELOW-SHADE. SOWN WIDE PARKE BELT / BANDING IN PIGURE S PATTERN ATTRACHED TO STEEZ WITH BRINGLE MAL, PLACE BEST AT A HEIGHT NO GREATER THATM THE HEIGHT THAT WILL SUPPORT THE TREE VERTICALLY. FINCHED SHADE OF PLANTING, INCLUDING BANK MULCH, TO BE EQUIVALENT TO NUMBERY GROWN GRACE, PINCH GRACE TO WEET TOPS OF CURBS, WALKS AND OPWERAYS, ETC. TREE STO. HT PER SPECE IN TOPOCIL FOR FIRST YEAR WATERING. SOMM DEPTH BANK MULCH APPLIED AT A aget or a MINIMUM DISTANCE OF VIDWI FROM TRUNC CLEAN CUT SOO EDGE. ENOWING CLAVO

I' MEPH STACCO MIRE FENCE

M GANGE GALANAZIO MIRE

OVERAP SQUANEZIO MIRE

OVERAP SQUANEZIONEZIO

CUE ALL MENTERE DEPTEZ

CUI MIRE DO PIT BASE,

ESCURE TO GROUND METH

ACCOMMISTANCES GROWING MEDIUM DEPTH AS PER SPEC.
FILL PLANTING HOLE WITH GROWING MEDIUM TO DONDS FULL, THEN REMOVE STRAPPING, CUT ALL BINDING MATERIAL, AND FOLD BURLAP INTO BOTTOM OF HOLE, COMPACT CROWING MEDIUM TO SON PROCEOUS DENSITY, TO REMOVE AIR POCKETS. COMPACT SUBSPACE UNDER ROOTBALL TO ION PROCTOR DENGTY, TO PROVENT THEE SETTLING AFTER COMPACTION, SCARPY SIDES AND BOTTOM OF PLANTING PIT. PLANTED HOLE EDGE WITH SHALLOW ANGLE. TREE AND SHRUB PLANTING

DCALE 128

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Sule C120 - 4185 Still Creek Drive Burnally, British Columbia, VSC 608 p; 604-264-0011 ; f; 604-264-0022

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Delivery of Management of the Control of the Contro

MICHITECT

G3 ARCHITECTURE INC.

PROJECT:

THE ARKELL
RESIDENTIAL DEVELOPMENT

670 FARRELL ROAD LADYSMITH, BC

PMG PROJECT NUMBER:

DRAWING TITLE:

### LANDSCAPE DETAILS

DATE 21.0CT 01 DRAWNO 0.

SCALE: AS MOTED
DRAWN: M
DESION:
CHART: MA

23 178

Page 86 of 159



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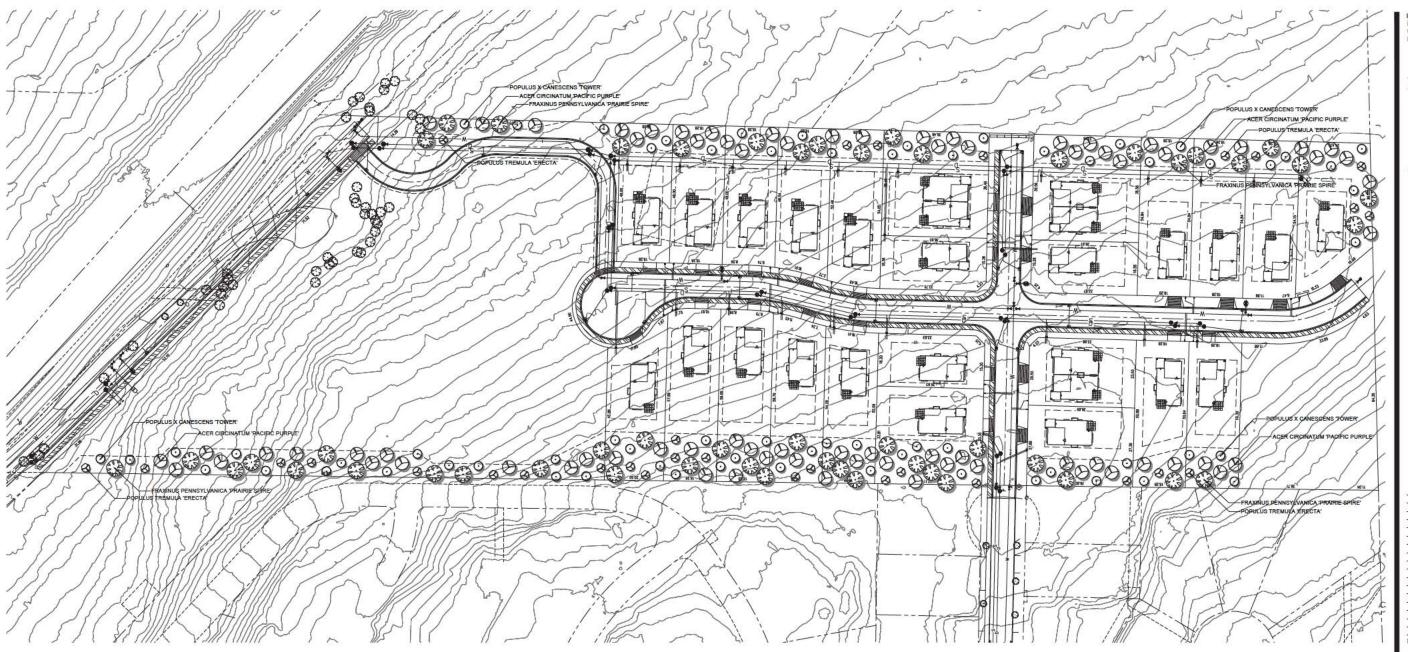
PROJECT:

THE ARKELL RESIDENTIAL DEVELOPMENT

670 FARRELL ROAD LADYSMITH, BC

AMENITY AREA ENLARGEMENTS


DESIGN CHOCD: PMG PROJECT NUMBER: 23-178



Schedule E - Landscape Tree Plan
DP 3060 22-14
670 Farrell Road
1 page

LAIT	SCHEDULE		
KEY QT	BOTANICAL NAME	COMMON NAME	PLANTED SIZE / REMARKS
JREE.		0.0000000000000000000000000000000000000	7,130,000,000,000,000,000,000,000,000
78	ACER CIRCINATUM 'PACIFIC PURPLE'	BRONZE VINE MAPLE	2.5M HT; B&B 3 STEM CLUMP
S 50	FRAXINUS PENNSYLVANICA 'PRAIRIE SPIRE'	PRAIRIE SPIRE ASH	6CM CAL; 1.8M STD; B&B
30	POPULUS TREMULA 'ERECTA'	SWEDISH COLUMNAR ASPEN	8CM CAL: B&B
(·) 68	POPULUS X CANESCENS 'TOWER'	TWOER POPLAR	8CM CAL: B&B

NOTES: \* PLANT SIZES IN THIS LIST ARE SPECIFIED ACCORDING TO THE BC LANDSCAPE STANDARD AND CANADIAN LANDSCAPE STANDARD, LATEST EDITION. CONTAINER SIZES SPECIFIED AS PER CNLA STANDARD. BOTH PLANT SIZE AND CONTAINER SIZE ARE THE MINIMUM ACCEPTABLE SIZES, \* REFER TO SPECIFICATIONS FOR DEFINED CONTAINER MEASUREMENTS AND OTHER PLANT MATERIAL REQUIREMENTS. \* SEARCH AND REVIEW. MAKE PLANT MATERIAL AVAILABLE FOR OPTIONAL REVIEW BY LANDSCAPE ARCHITECT AT SOURCE OF SUPPLY. AREA OF SEARCH TO INCLUDE LOWER MAINLAND AND FRASER VALLEY. \* SUBTITUTIONS OF THE PLANT METTERN APPROVAL FROM THE LANDSCAPE ARCHITECT PRIOR TO MAKING ANY SUBSTITUTIONS TO THE SPECIFIED MATERIAL. UNAPPROVED SUBSTITUTIONS WILL BE REJECTED. ALLOW A MINIMUM OF FIVE DAYS PRIOR TO DELIVERY FOR REQUEST TO SUBSTITUTION SO AND SUBJECT TO BE CLANDSCAPE STANDARD AND CANADIAN LANDSCAPE STANDARD. DEFINITION OF CONDITIONS OF AVAILABILITY. \* ALL LANDSCAPE MATERIAL AND WORKMANSHIP MUST MEET OR EXCEED BC LANDSCAPE STANDARD AND CANADIAN LANDSCAPE STANDARD LATEST EDITION. \* ALL PLANT METERIAL MUST BE PROVIDED FROM CERTIFIED DISEASE FREE NURSERY. \* BIO-SOLIDS NOT PERMITTED IN GROWING MEDIUM UNLESS AUTHORIZED BY LANDSCAPE ARCHITECT.

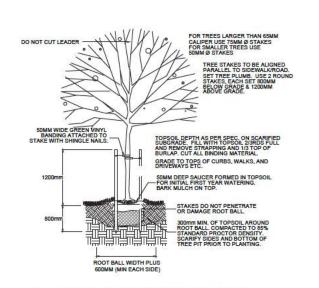

Page 88 of 59 1-07

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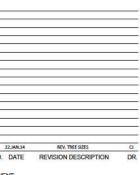
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Suite C100 - 4185 Still Creek Drive Burnaby, British Columbia, V5C 6G9 p: 604 294-0011 ; f: 604 294-0022

SEAL





ROJECT:

TREE PLANTING PLAN

670 FARRELL ROAD LADYSMITH


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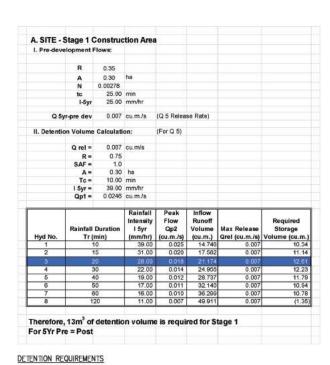
LANDSCAPE TREE PLAN

DATE:	21.DEC.08
SCALE:	1"=50"-0"
DRAWN:	RJ
DESIGN:	RJ
CHKD:	MCY

L1

PMG PRO JECT NI IMBER-



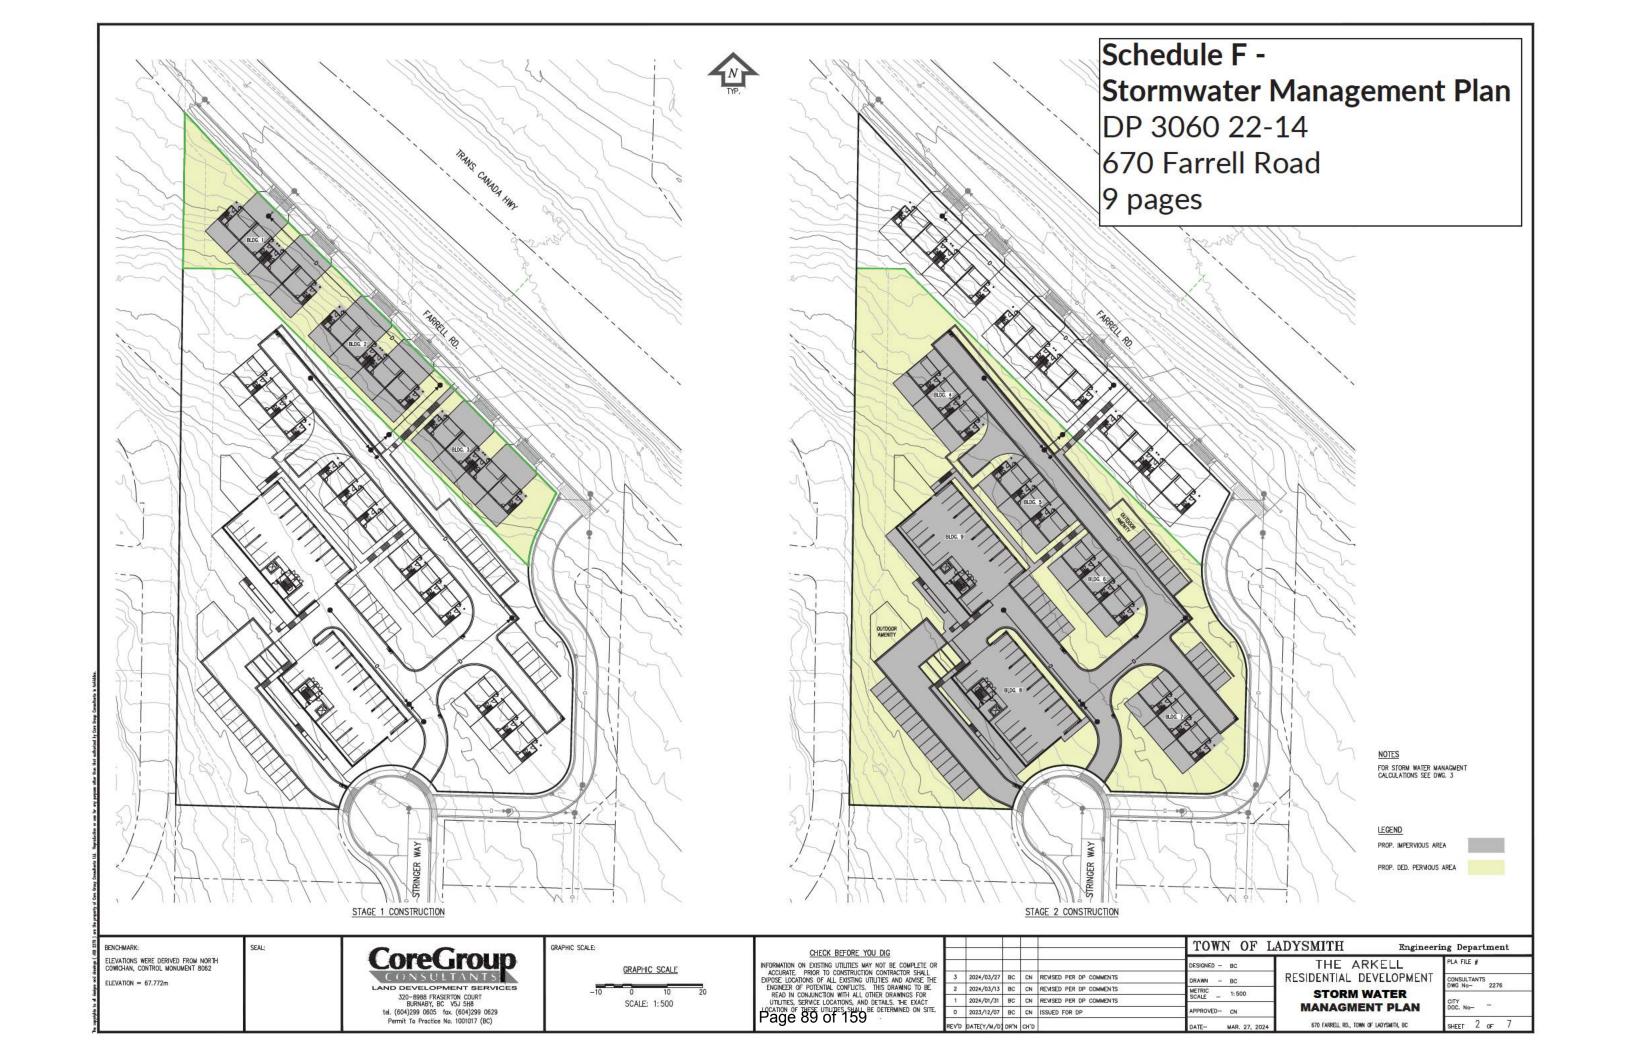

1.16 ha 0.00278 25.00 min Q 5yr-pre dev 0.028 cu.m./s (Q 5 Release Rate) II. Detention Volume Calculation: (For Q 5) Q rel = 0.028 cu.m/s
R = 0.75
SAF = 1.0
A = 1.66 ha
Tc = 10.00 min
1 5yr = 39.00 mm/hr
Qpt = 0.0941 cu.m/s | Inflow | Runoff | Volume | Storage | Storage | Storage | Volume (cu.m.) | Qrel (cu.m./s) | Volume (cu.m.) | 094 | 56.437 | 0.028 | 39.55 | 42.62 | 42.62 | | Rainfall | Peak | Inflow | Runoff | Volume | Modern | M Tr (min) Therefore, 49m³ of detention volume is required for Stage 2

For 5Yr Pre = Post

A. SITE - Stage 2 Construction Area

#### DETENTION REQUIREMENTS

INDIVIDUAL TOWNHOUSE DETENTION =  $4.5m^3 \times 4 = 18m^3$  INDIVIDUAL APARTMENT DETENTION =  $16m^3 \times 2 = 32m^3$  TOTAL DETENTION ACHIEVED =  $18^3 + 32^3 = 50m^3$ 

ELEVATIONS WERE DERIVED FROM NORTH COWICHAN, CONTROL MONUMENT 8062 ELEVATION = 67.772m

CoreGroup LAND DEVELOPMENT SERVICES 320-8988 FRASERTON COURT BURNABY, BC V5J 5H8

tel. (604)299 0605 fax. (604)299 0629 Permit To Practice No. 1001017 (BC)

GRAPHIC SCALE;

INDIVIDUAL TOWNHOUSE DETENTION = 4.5m3 x 3 = 13.5m3

GRAPHIC SCALE SCALE: 1:1000

CHECK BEFORE YOU DIG INFORMATION ON EXISTING UTILITIES MAY NOT BE COMPLETE ACCURATE. PRIOR TO CONSTRUCTION CONTRACTOR SHAL EXPOSE LOCATIONS OF ALL EXISTING UTILITIES AND ADVISE ENGINEER OF POTENTIAL CONFLICTS. THIS DRAWING TO B READ IN CONJUNCTION WITH ALL OTHER DRAWINGS FOR UTILITIES, SERVICE LOCATIONS, AND DEFAUS. THE EXACT LOCATION OF THESE UTILIZIES, SHALL BE DETERMINED ON S PAGE 90 OT 159

$\vdash$					TOWN OF L	AD'
OR				10	DESIGNED - BC	
E 3	2024/03/27	BC	CN	REVISED PER DP COMMENTS	DRAWN - BC	R
2	2024/03/13	BC	CN	REVISED PER DP COMMENTS	METRIC N.T.S.	
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REV'I	DATE(Y/M/D	DR'N	CH'D		DATE- MAR. 27, 2024	

YSMITH Engineering Department THE ARKELL RESIDENTIAL DEVELOPMENT STORM WATER INFILTRATION CALCULATIONS 670 FARRELL RD., TOWN OF LADYSMITH, BC

CONSULTANTS DWG No- 2276 SHEET 3 OF 7



April 22, 2024 PROJECT: 2276

Town of Ladysmith 132C Roberts Street Ladysmith, BC V9G 1A2

TO: Mr Andrew Wilson

**Planner** 

RE: The Arkell Multi Family Development 670 Farrell Road, Ladysmith

Development Permit - Stormwater Management

The following information is in support of the development Permit Application for 670 Farrell road and is in response to questions raised in Mr Andrew Wilson's email dated April 18, 2024.

 Attached are copies of the previously submitted Stormwater Management plans that provide preliminary volume calculations for each stage of the development. These calculations will be refined as the design advances to detailed design stage.

Roof drainage will discharge directly to underground detention tanks located within the building footprint or adjacent to the buildings. Road drainage will/may be detained in oversized storm sewer pipes located in the roadways. If infiltration is possible, infiltration galleries will be located in landscaped areas adjacent to buildings or roadways.

- Attached are a couple of sample designs that will be applied to this
  project. As the design advances to Building Permit stage, construction
  details will be provided. Preliminary calculations below show how the
  detention requirements can be apportioned to each building. The total site
  volume detention = 62 m3
  - Stage 1: Each townhouse unit fronting Farrell Road will require 1.1 m3 of detention. (13m3 /12=1.1m3)
  - Stage 2: Each townhouse will require approximately 2 m3 ( 24m3 /12) and each Apartment will require 12.5 m3 ( 25m3 /2 =12.5m3).
- Where possible, landscape areas will have storm water source control and infiltration, however, due to the presence of rock on the site, infiltration opportunities will be limited or not practical.

4. The site will be serviced by an existing storm sewer connection located at the northwest corner of the site off Farrell Road. We do not anticipate any issues relating to the extension of this service.

We trust that the above is to your satisfaction, however, should you require additional information please contact the undersigned.

Yours truly,

CORE GROUP CIVIL CONSULTANTS LTD.

Permit to Practice # 101017(BC)

Cormac Nolan, P.Eng

Cormac Nolan

A SITE - Stage 1 Construction Area

R 0.26 A 0.20 ha N 0002/5 IS 25:00 min 1-5ys 23:00 minute

Q Syn-phe day 0 907 cu m /s (Q 5 Release Rate)

# Defeator Volume Calculation (For Q 5)

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	50	17 05	C 011	12:140	5 007	10 94
7	30	16.00	Carp	347W	0.003	10.75
- 11	120	11.00	C 927	49.911	0.067	(1.32

Therefore, 13m3 of detention volume is required for Stage 1 For SYr Pro = Post

DETENTION REQUIREMENTS

INDIVIDUAL TOWNSOUSE DETENTION = 4.5m2 x 3 = 13.5m2

A. SITE - Stage 2 Construction Area

R 0.35 A 1.16 he N 0.002/6 to 26.00 min 149/1 25.00 mm/m

G Sys-pro-des 9.00% camers (G 5 /fenase Hale)

II. Detention Volume Catsulation: (For Q 5)

Q mil = 0.020 cum/s R = 075 SAF = 10 A = 118 hs Te = 1000 men t byr = 3900 men/s Cpt = 0.0941 cum/s

Hyd No.	Hainfall Dyrabun Tr (min)	Rainfeil Interety 1 Syr (medic)	Feat Flow Qp2 (cu.m./s)	Funoff Volume (sum.)	Max Referen	Hoquized Storage Valance (su.m.)
	10	22.20	0.094	10.437	6.420	29.05
- 7	16	31.00	0.04	47,290	1,028	43.63
1	2	29 00	0.074	11.038	0.000	10 26
	30	25.00	0 553	15 500	6:020	
3	40	19:00	0.646	119 550	E.G.:9	40.11
n-	50	17.00	0.041	113 004	(:0,0	
70	10	16.00	0.639	138.572	6.020	
11	120	11.00	0.07	101.017	6 (42)	16-30

Therefore, 49m<sup>3</sup> of detantion volume is required for Stage 2 For SYr Pre = Post

DETENTION REQUIREMENTS

INDIVIDUAL TOWNHOUSE DETENTION =  $4.5m^3$  x =  $16m^3$  NONSOUAL APARTMENT DETENTION =  $16m^3$  x  $2 = 32m^3$  TOTAL DETENTION ACRIEVED =  $16^4 + 32^3 = 50m^4$ 

ELEVATIONS HERE DERIVED FROM HORTH COMICHAN, CONTROL MONUMENT 8062 ELEVATION = 67.772m


CoreGroup LAND DEVELOPMENT BEHVICES 320-9985 FRASERION COURT BURNASY, 8C VSJ 545 tel (504)299 0605 for (604)299 0829 Permit To Procisio No 100/017 (6C)

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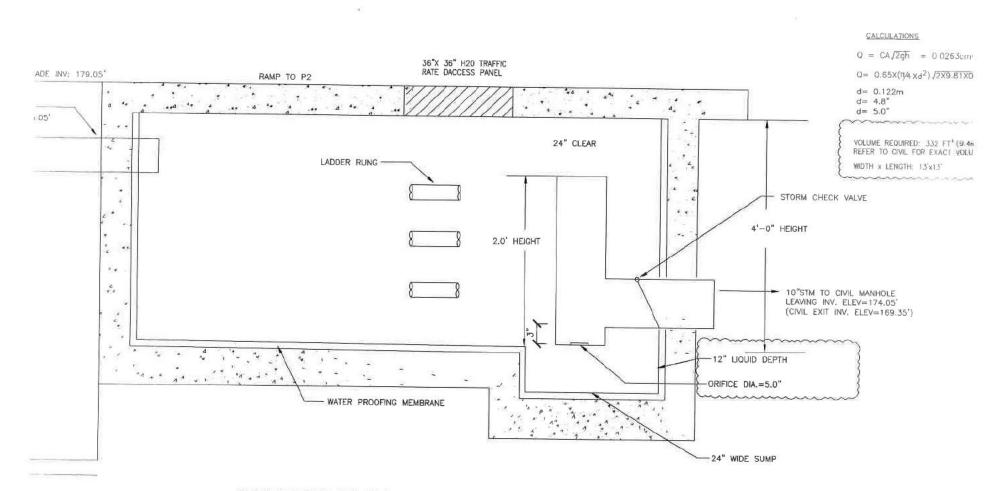
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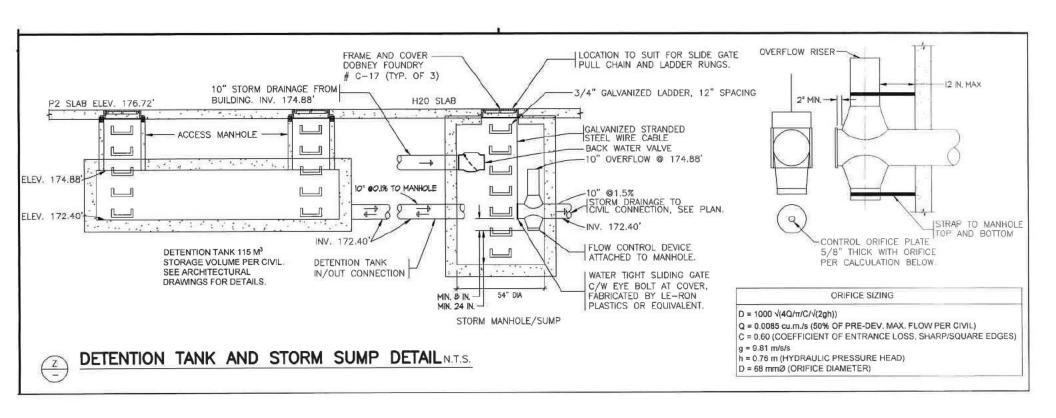
Engineering Department THE ARKELL RESIDENTIAL DEVELOPMENT STORM WATER INFILTRATION CALCULATIONS




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DETENTION TANK DETAIL SCALE: N.T.S.



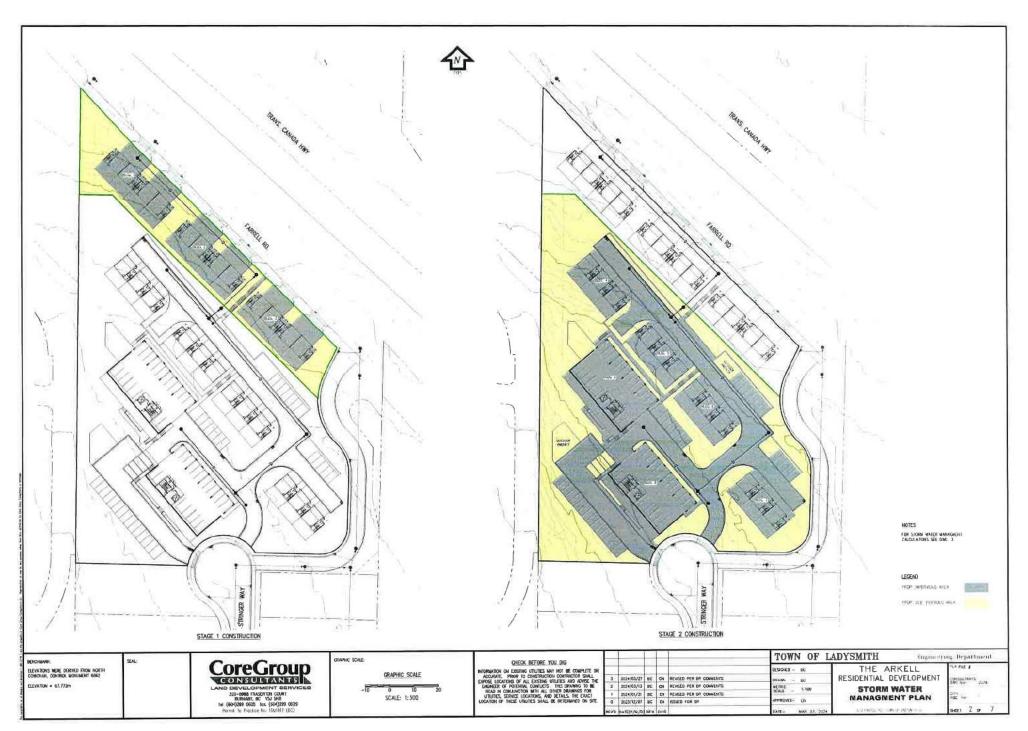

Schedule G -Waste Management Plan DP 3060 22-14 670 Farrell Road 5 pages

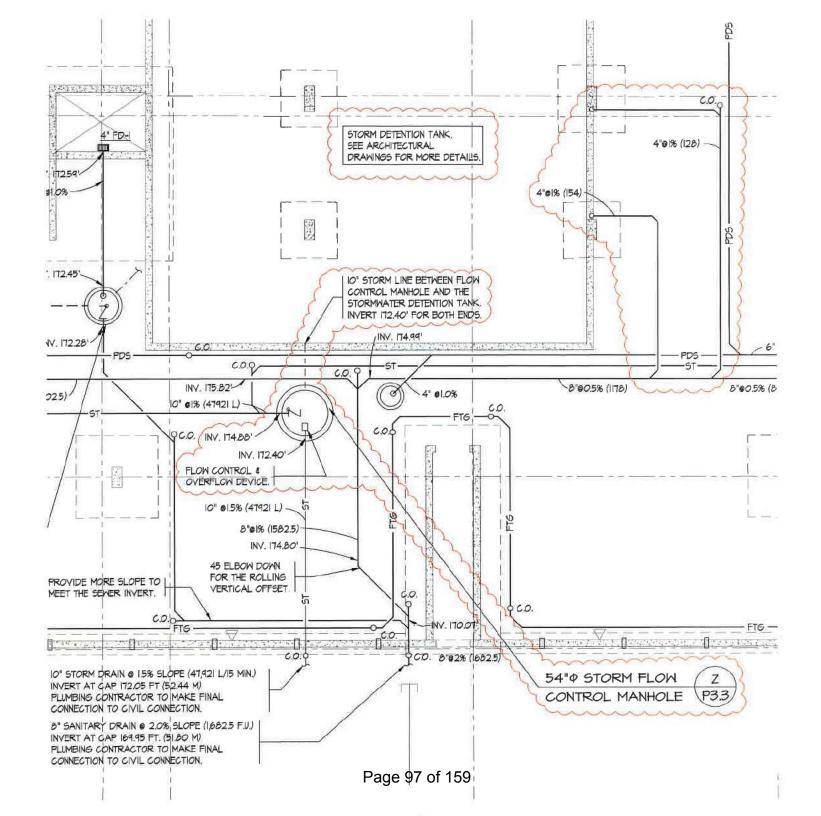



**Arkell Apartments and Townhouses** 

Waste Management Plan



# Arkell Apartments and Townhouses Waste Management Plan

## **Project Overview**

Makon Projects Ltd. is a General Contractor executing commercial, institutional, and multi-family construction projects. Our projects range from new construction to tenant improvements and renovations.

As the general contractor for the Arkell Apartments and Townhouses, our objective is to create a sustainable, modern, and vibrant community that harmonizes with the surrounding area's natural beauty.

Makon uses experience from construction phasing to enhance efficiency and reduce waste by allowing for a focused, systematic approach to each stage of development. This approach enables better resource allocation, ensuring that materials and workforce are optimized for specific project milestones, leading to a more sustainable and resource-efficient construction process.

## Assessment & Strategy

Efficient material planning is crucial to minimizing waste. Makon Projects Ltd. will conduct detailed assessments of project requirements, order materials in accurate quantities, and maintain a well-organized product inventory. This helps prevent overordering and ensures that materials are used optimally, reducing the likelihood of excess waste.

A construction coordinator will be responsible for training workers, subcontractors, and suppliers on proper waste management procedures for the work at the project site. The coordinator will distribute this waste management plan to each subcontractor when they begin on-site work. Workers, subcontractors, and suppliers shall be trained on proper waste management procedures for work at the project site.

Regular construction management meetings will review the procedures and locations established for salvage, recycling, and disposal. The specific areas of the project site designated for separating materials to be salvaged, recycled, reused, donated, and sold are noted on the site and building plans in Appendix A.

The following strategies will be considered to reduce the quantity of waste generated on-site:

- 1. Give preference to supply companies that can explicitly provide material in the dimensions needed for the project or in quantities closer to the required amount. A phased construction approach allows for more accurate material ordering.
- 2. Give preference to supply companies that provide minimal packaging beyond that required for product protection or ship materials in reusable or returnable packaging such as pallets or containers.
- 3. Give preference to supply companies that accept returns of unused construction material.
- 4. Protect materials from damage by storing them away from equipment traffic patterns, elevating them off the ground, holding them under cover, and keeping them level to prevent warping or twisting. Makon uses shipping containers to store and protect materials on site.
- 5. Use products efficiently by keeping them organized and emptying one pallet or shipment before opening the next. Having material handling machines on site promotes organization and efficiency.



## Arkell Apartments and Townhouses

## Waste Management Plan

- 6. Additional waste reduction strategies should be considered by each contractor and brought to the construction manager for approval. These efforts are optional, but popular methods include Clean concrete chunks, old brick, broken blocks, and other masonry rubble that can be used as backfill along foundation walls.
- 7. Leftover dirt and aggregate from excavation may be stored separately and sold or reused in site Landscaping.
- 8. Branches and trees from site clearing can be stored separately and chipped for use on the site as landscaping mulch.
- 9. Set aside, in a marked and designated area, lumber and plywood/oriented strand board (OSB) cut-offs that can be used as fire blocking, spacers in header construction, and other ways.
- 10. Set aside, in a marked and designated container, clean sawdust for use in compost piles or around planting areas. Avoid sawdust that might contain painted or treated wood. This should be bagged separately and sent to appropriate facilities.
- 11. Set aside, in a marked and designated area, large drywall scraps for use as filler pieces in small hidden areas.
- 12. Install leftover insulation in interior wall cavities if it cannot be used on another job.

The following materials will be identified and categorized into different types of construction waste, including but not limited to:

- Concrete and masonry
- Wood
- Metals
- Plastics
- Cardboard and paper
- Glass
- Insulation materials
- Hazardous Materials

## **Material Handling Procedures**

#### a. Concrete and Masonry:

- Salvage and reuse concrete where feasible.
- Crush concrete for use as fill or aggregate.
- Separate concrete and masonry debris for recycling.

#### b. Wood:

- Salvage and reuse wood materials on-site where possible.
- Separate wood waste for recycling or use as biomass fuel.
- Dispose of treated wood separately from untreated wood.

#### c. Metals:

- Collect and recycle all scrap metal.
- Separate ferrous and non-ferrous metals for recycling.
- Encourage the use of prefabricated materials to minimize metal waste.



## Arkell Apartments and Townhouses Waste Management Plan

#### d. Plastics:

- Minimize the use of plastic materials where possible.
- Identify and separate plastic waste for recycling.
- Work with suppliers to reduce excessive packaging.

#### e. Cardboard and Paper:

- Set up dedicated bins for cardboard and paper recycling on-site.
- Flatten and bundle cardboard for efficient recycling.
- Minimize paper use through digital documentation.

#### f. Glass:

- Salvage and reuse glass materials when applicable.
- Separate glass waste for recycling.
- Explore opportunities for architectural reuse of glass components.

#### g. Insulation Materials:

- Prioritize the use of recyclable and environmentally friendly insulation materials.
- Collect and recycle insulation materials at the end of their lifecycle.
- Dispose of hazardous insulation materials according to regulations.

#### h. Hazardous Materials:

- Identify hazardous materials used in construction.
- Implement proper handling, storage, and disposal procedures for hazardous materials.
- Comply with local, provincial, and federal regulations for hazardous waste management.

## **On-Site Sorting and Collection**

Clearly, labelled waste bins will be placed around the job site for workers to place materials in their respective locations.

Workers should be educated on handling, storage, and disposal of materials to prevent unnecessary waste. Maintaining a culture of awareness and responsibility regarding waste reduction can empower employees to actively participate in minimizing waste on the job site.

## **Recycling Program**

Types of material disposal bins on site will include, but are not limited to:

- Wood
- Metals
- Cardboard
- Compost (if applicable)



## Arkell Apartments and Townhouses Waste Management Plan

Materials will be disposed of promptly to prevent congestion on site or ruin the materials in a way that prohibits them from being recycled.

General waste produced from the project will be disposed of at either Milner Recycling or D.B.L. Disposal Services. This waste is recycled at these facilities before being transferred to a landfill.

## **Continuous Improvement**

Feedback mechanisms will be implemented for staff and subtrades to continuously improve these waste management practices.

This waste management plan will be regularly reviewed and updated based on previous project experiences.

By adhering to this construction waste management plan, the project aims to adhere to LEED Gold standards while minimizing the environmental impact of construction activities. Regular monitoring and continuous improvement efforts will be implemented throughout the project's lifecycle.

Schedule H - Geotechnical Assessment DP 3060 22-14 670 Farrell Road 23 pages

## GEOTECHNICAL ASSESSMENT

Multi-Family Developments 670 Farrell Road (Lot 12), Ladysmith, BC

## Prepared For:

Core Group Civil Consultants 320 – 8988 Fraserton Court Burnaby, BC V5J 5H8

Attention: Mr. Sean Caroll

September 20, 2023

File No.: E2668.01 Revision No.: 00 Prepared by: Chris Hudec, M.A.Sc., P.Eng.

Chris Hudec, M.A.Sc., P.Eng. John Hessels, AScT

Lewkowich Engineering Associates Ltd. 1900 Boxwood Road Nanaimo, BC, V9S 5Y2 250-756-0355 (Office) 250-756-3831 (Fax) www.lewkowich.com

Permit to Practice Number: 1001802





FILE NO.: E2668.01

DATE: September 20, 2023



#### **DISCLAIMER**

- 1. Lewkowich Engineering Associates Ltd. (LEA) acknowledges that this report, from this point forward referred to as "the Report," may be used by the Town of Ladysmith (ToL) as a precondition to the issuance of a subdivision permit and that this Report and any conditions contained in the Report may be included in a restrictive covenant under Section 56 of the Community Charter and registered against the title of the Property at the discretion of the ToL.
- 2. This report has been prepared in accordance with standard geotechnical engineering practice solely for and at the expense of Core Group Civil Consultants. We have not acted for or as an agent of the ToL in the preparation of this report.
- 3. The conclusions and recommendations submitted in this report are based upon information from relevant publications, a visual site-assessment of the property, anticipated and observed subsurface soil conditions, current construction techniques, and generally accepted engineering practices. No other warrantee, expressed or implied, is made. If unanticipated conditions become known during construction or other information pertinent to the development becomes available, the recommendations may be altered or modified in writing by the undersigned.
- 4. This Report was authored, to the best of our knowledge at the time of issuance, with considerations for local requirements specific to the Authority Having Jurisdiction (AHJ and MOTI) and their standards for the preparation of such reports, the 2018 British Columbia Building Code (BCBC), and current engineering standards. Updates to municipal bylaws, policies, or requirements of the AHJ, or updates to the BCBC and/or professional practice guidelines may impact the validity of this Report.
- 5. This report has been prepared by Mr. Chris Hudec, M.A.Sc., P.Eng. and by Mr. John Hessels, AScT. Messrs. Hudec and Hessels are both adequately experienced and are also members in good standing with their respective professional associations; and Engineers and Geoscientists of British Columbia (EGBC) Applied Science Technologists and Technicians of British Columbia (ASTT).

FILE NO.: E2668.01

DATE: September 20, 2023



### **EXECUTIVE SUMMARY**

- The following is a brief synopsis of the Property, assessment methods, and findings presented in the Report. The reader must read the Report in its entirety; the reader shall not rely solely on the information provided in this summary.
- 2. The subject property, 670 Farrell Road (Lot 12), from this point forward referred to as "the Property," is located on the east coast of Vancouver Island within the jurisdictional boundaries of the ToL. The proposed development for the Property at the time of this report consists of the construction of seven (7) townhouse buildings, and two (2) multi-family buildings on the subject property.
- A site-specific hazard assessment was conducted to identify potential geotechnical hazards for the subject Property. No significant geotechnical hazards were identified.
- 4. The findings confirm the development is considered safe as proposed.

List of Abbreviations Used in the Report

Abbreviation	Title
BCBC	British Columbia Building Code
ВР	Building Permit
EGBC	Engineers and Geoscientists of British Columbia
LEA	Lewkowich Engineering Associates Ltd.
ToL	Town of Ladysmith
MoTI	BC Ministry of Transportation and Infrastructure
CVRD	Cowichan Valley Regional District
MoE	BC Ministry of Environment
CGC	Core Group Civil Consultants

FILE NO.: E2668.01

DATE: September 20, 2023



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#### 1.0 INTRODUCTION

#### 1.1 General

a. As requested, LEA has carried out a Geotechnical Assessment of the above referenced property. This report provides a summary of our findings and recommendations.

## 1.2 Background

- a. We understand that the proposed development consists of the construction of seven (7) townhouse buildings, and two (2) multi-family buildings.
- b. The property is within the jurisdictional limits of the ToL. As per the ToL Official Community Plan, the property is located within two Development Permit Areas, DPA 4 Multi-Unit Residential and DPA 7 Hazard Lands. DPA 4 is primarily Form and Character with a sustainability component and does not pertain to this report. DPA 7 relates to steep slopes and slope stability, which this report addresses.
- c. The legal address for 670 Farrell Road is: LOT 12, DISTRICT LOT 41, OYSTER DISTRICT, PLAN EPP119981.

## 1.3 Assessment Methodology

- a. This assessment included a desktop review of relevant background information, including available development plans, registered covenants on title, aerial photographs, and published geology, topography and floodplain mapping (if any). Please refer to the list of references at the end of this report.
- b. A site reconnaissance was conducted on September 14, 2023, to visually assess current site conditions.
- c. This assessment was prepared with consideration of the referenced EGBC *Guidelines for Legislated*Landslide Assessments for Proposed Residential Development in British Columbia.

#### 2.0 SITE CONDITIONS

## 2.1 Physical Setting

a. The subject property is located within the ToL near its eastern extents. The property is immediately bordered to the north by Farrell Road, then the Trans Canada Highway, to the west by single and multi family residential properties, to the south by a new residential subdivision yet to be built out, and to the east by undeveloped and rural residential property. The property is currently accessed from the eastern end of Farrell Road and the new road in the subdivision to the south named Stringer Way. In the future, three townhome buildings will be accessed from Farrell Road, with the remainder of the buildings

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accessed via Stringer Way. Refer to Figure 1 below (Google Maps).



**Figure 1: Property Location** 

### 2.2 Terrain and Features

- a. The property lies at the base of the foothills of the Nanaimo Lakes Highlands which rise to the west. The terrain generally rises from the northeast to the southwest, with elevations increasing from approximately 65m to 90m geodetic from Farrell Road to the cul-de-sac at the end of Stringer Way, for a total vertical relief of 25m. The terrain within the property can be generally described as gently rolling to hilly (i.e. average slope angles vary between 10 to 26 degrees from horizontal).
- b. No significant slopes were observed during our site visit, other than newly created bedrock slopes along the new Emergency Access Road which approach vertical. The steepest observed natural slopes approach a 2H:1V angle. Refer to Figures 2.2.a and 2.2.b below.

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Figure 2.2.a: Bedrock slope



Figure 2.2.b: Natural slope

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c. At the time of our field review, the property did not contain any buildings or structures. The Emergency Access Road was constructed as part of the new subdivision to the south. The area fronting Farrell Road has been manipulated to create a 2H:1V or shallower slope above a newly constructed sidewalk. Refer to Figure 2.2.c below.



Figure 2.2.c: Slope above sidewalk along Farrell Road

d. The Property is vegetated with second and third growth forest. Some areas were cleared and manipulated within 10m of Farrell Road, the Emergency Access Road, and Stringer Way. The manipulation was to regrade soil into stable slopes for road support. Refer to Figure 2.2.d below.



Figure 2.2.d: Slope for road support

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DATE: September 20, 2023



#### 2.3 Watercourses

a. No watercourses were observed within the subject property.

# 2.4 Regional Geology

- a. Based on surficial geology mapping<sup>1</sup>, the property is located within a composite soil structure, consisting of the more prominent Squally formation (a colluvium deposit of rapidly-draining, gravelly loamy sand), and the less prominent Shawnigan formation (a moraine deposit of well-draining, gravelly sandy loam).
- b. Bedrock geology for the area<sup>2</sup> is classified as granodioritic intrusive rock of the Island Plutonic Suite from the early to mid Jurassic period.
- c. There are no known active fault lines that cross the subject property.

#### 2.5 Soil Conditions

- a. A subsurface investigation was not included as part of this Geotechnical Hazard Assessment. Visual inspection of the site allowed for observations of minor soil exposures within the subject property.
- b. Observed soil conditions were consistent with the reported surficial geology mapping, and predominately consisted of silty sands and gravels overlying granitic bedrock at shallow depths. We expect thickness of soil cover would generally be in the range of 0 to 5m, however thicker localized soil deposits may be encountered. Bedrock outcrops and exposures were observed throughout the property.
- c. Fill materials were observed in some areas near Farrell Road, the Emergency Access Road, and Stringer Way, presumably placed as part of the cut and fill operations for the road construction.

#### 2.6 Groundwater

- a. There was no evidence of ponding water, nor abnormal groundwater conditions observed during our visual reconnaissance of the property.
- b. Groundwater levels can be expected to fluctuate seasonally with cycles of precipitation. Groundwater conditions at other times and locations can differ from those observed at the time of our assessment.

#### 3.0 DISCUSSIONS AND RECOMMENDATIONS

#### 3.1 Covenant Review

- a. As part of our assessment, we have reviewed the legal title of the subject property, specifically relative to any restrictive covenants that may impact the conclusions or recommendations made in this report.
- b. At the time of this report there are six (6) covenants for the parent parcel, which includes the subject

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Property. Of the six covenants, only one has geotechnical relevance. Covenant CB840905 contains the geotechnical assessment of the parent parcel. This report is more specific to Lot 12.

# 3.2 Steep Slopes

a. In general, the Property contains gentle to moderately steep slopes which can safely accommodate townhouse and multi-family residential buildings under geotechnical review. No building shall be constructed on a bedrock slope that is steeper than 1 Horizontal to 1 Vertical (1H:1V, or 45 degrees), or a soil slope that is steeper than 2H:1V (27 degrees). Where applicable, a safe setback to the crest and toe of bedrock slopes steeper than 1H:1V, and soil slopes steeper than 2H:1V, shall be established at the time of development/building permit application.

- Based on the development plans (attached) site preparation will include cut and fill operations to facilitate
  level building and parking areas. Some areas will utilize retaining walls to accommodate grade changes.

  Most of the retaining walls will be incorporated into the rear walls of proposed buildings. However, some
  retaining walls will support parking areas or driveways within the development.
- c. As previously described, no slopes steeper than 2H:1V were observed on the property (except the rock cut along the new Emergency Access Road), though there may be localized steeper areas. Design details can be provided upon request for areas that may include steeper slopes and associated walls.

### 3.3 Seismic Criteria

- a. No liquefiable or compressible soils were encountered during our field review, nor are any expected to be encountered during construction.
- b. Based on the 2018 British Columbia Building Code, Division B, Part 4, Table 4.1.8.4.A, "Site Classification for Seismic Site Response," the soil and bedrock strata observed during our field review would be classified as "Site Class C" (very dense soil and soft rock).

# 3.4 Roadways and Utilities

a. There is near surface bedrock present in areas of the proposed development. Where bedrock is near the ground surface, it is possible that roadways and utility service trench lines will require blasting to provide sufficient depth and spacing between service lines. Supplemental investigation to determine depth to bedrock may be required for planning purposes.

#### 3.5 Lateral Earth Pressures

a. Any future retaining wall construction within the Property shall be reviewed by the Geotechnical and/or Structural Engineer(s).

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b. Lateral earth pressure coefficients (K) for the design of the cast-in-place retaining walls are outlined in Table 1. It is assumed that there will be a level (0 degree from horizontal) backslope and no additional surcharge on the wall. It is noted that the methods employed are estimates and further analysis may be required after dimensions of the proposed structure have been determined. Drainage requirements for any wall construction shall be reviewed by the Geotechnical Engineer prior to construction.

- c. An average soil friction angle of 27° has been used to calculate the lateral earth pressure coefficients. It is assumed that retained soils are well compacted, cohesion-less sands and gravels, with a unit weight of 21 kN/m³.
- d. The Mononobe-Okabe (M-O) Method has been used to calculate the seismic active lateral earth pressure coefficients. The static active lateral earth pressure has been calculated using Coulomb's theory. The results for the passive earth pressures have been calculated using Rankine theory.
- e. The seismic thrust coefficient provides a value that combines both dynamic and static forces. Seismic forces used reflect values from the attached 2015 National Building Code interpolated seismic hazard values for the specific Property which are 0.483 Peak Ground Acceleration (PGA) (2% in 50year probability) and 0.257 PGA (10% in 50year probability).
- f. The total thrust for the static case acts through a point that is approximately H/3 above the toe of the wall. The dynamic component of the seismic thrust acts through a point at approximately 0.6H above the toe of the wall. See the following Table 3.6.1 for design values.

Lateral Earth Pressure Conditions	Earth Press	sure Coefficient (K)
Seismic Passive	Кр	2.66
Static Active	Ka	0.33
Seismic Active	Ke	0.55

Table 3.6.1 - Lateral Earth Pressure Coefficients

g. The total thrust resulting from lateral earth pressures under each of the conditions outlined in Table 3.6.1 may be calculated using the relationship in Table 3.6.2.

P = 0.5 K γ H <sup>2</sup>
P = Total Thrust (kN/m Length of Wall)
K = Earth Pressure Coefficient
γ = Soil Unit Weght (kN/m³)
H = Height of Wall (m)

Table 3.6.2 - Calculation and Values for Lateral Earth Pressures

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h. The seismic active coefficient provides a value that combines both static and dynamic forces to determine total active thrust (Pae). The static component (Pa) acts through a point that is approximately H/3 above the toe of the wall. The dynamic component (ΔPae) acts through a point at approximately 0.6H above the toe of the wall. The total active thrust may then be considered to act at a height from the base of the wall using the following relationship in Table 3.6.3.

h = [ Pa (H/3) + ΔPae (0.6H) ] ÷ Pae
h = Height from Base of Wall (m)
Pa = Static Active Thrust (kN/m)
Pae = Total Active Thrust (kN/m)
ΔPae = Dynamic Active Thrust (kN/m)

Table 3.9.3 – Height from base of wall for Total Active Thrust

# 3.6 Retaining Walls

- a. There are several retaining walls proposed for the development. All retaining walls taller than 4 feet (1.2m), and any walls shorter than 4 feet (1.2m) that support structures require engineering, drawings, and associated building permits.
- Walls shorter than 4 feet (1.2m) are commonly called Landscape Walls to distinguish themselves from Retaining Walls, and do not require engineering in accordance with the ToL Retaining Wall bylaw (2014):
  - 5.19. Retaining Walls Regulations:
  - a) A single Retaining Wall may not exceed 1.2 metres in Height.
  - b) All Retaining Walls located within 1.2 metres of each other will be collectively considered a single retaining wall for the purposes of determining Height.
- c. Landscape walls do not pose slope stability risks because they are small enough that deep seated slope stability failures do not occur due to the wall. It is LEAs opinion that landscape walls do not pose risk to the stability of buildings.

#### 4.0 CONCLUSIONS

a. From a geotechnical point of view, and provided the recommendations in this report are followed, the land is considered safe for the use intended (defined for the purposes of this report as a residential

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development), with the probability of a geotechnical failure resulting in property damage of less than:

i. 2% in 50 years for geotechnical hazards due to seismic events, including slope stability; and,

ii. 10% in 50 years for all other geotechnical hazards.

b. Based on our field review of the subject property and the referenced project documentation, there are safe building sites available on the subject property for all proposed townhomes and multi-family buildings. The property will likely require manipulation of the soils and/or bedrock and possible retaining walls and/or rock cuts to accommodate a civil works, driveways, parking lots, and buildable areas for the various buildings.

c. We recommend that prior to the construction for each proposed building, the proposed building plan and survey for each building be reviewed by a Geotechnical Engineer.

#### 5.0 ACKNOWLEDGEMENTS

a. Lewkowich Engineering Associates Ltd. acknowledges that this report may be requested by the Building Inspector (or equivalent) of the ToL as a precondition to the issuance of a building permit. It is acknowledged that the Approving Officers and Building Officials may rely on this report when making a decision on application for development of the land. We acknowledge that this report has been prepared solely for, and at the expense of Core Grope Civil Consultants. We have not acted for or as an agent of the ToL in the preparation of this report.

#### 6.0 LIMITATIONS

a. The conclusions and recommendations submitted in this report are based upon the information available at the time of this assessment. The recommendations given are based on the anticipated subsurface soil conditions, current construction techniques, and generally accepted engineering practices. No other warrantee, expressed or implied, is made. If unanticipated conditions become known during construction or other information pertinent to the development become available, the recommendations may be altered or modified in writing by the undersigned.

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# 7.0 CLOSURE

a. Lewkowich Engineering Associates Ltd. appreciates the opportunity to be of service on this project. If you have any comments, or additional requirements at this time, please contact us at your convenience.

Respectfully Submitted, Lewkowich Engineering Associates Ltd.

John Hessels, AScT Managing Partner Chris Hudec, M.A.Sc., P.Eng. Senior Project Engineer

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DATE: September 20, 2023



#### 8.0 ATTACHMENTS

1. EGBC Appendix D , Landslide Assessment Assurance Statement.

- 2. 2015 National Building Code Seismic Hazard Calculation.
- 3. G3 Architecture Inc., "Residential Development, 670 Farrell Road, Ladysmith BC", dated September 11, 2023, Drawing Numbers DP110 and DP150.

#### 9.0 REFERENCES

- 1. BC Ministry of Environment, *Soils of South Vancouver Island British Columbia*, Soil Survey Report No. 44, Sheet 1, dated 1986.
- 2. iMapBC interactive web-map, accessed March 2020.
- 3. BC Ministry of Environment, *Geomorphology of Vancouver Island: Mass Wasting Potential*, Report No. RR 01, December 2005.
- 4. BC Ministry of Forests, Lands, Natural Resource Operations and Rural Development, *Flood Hazard Area Land Use Management Guidelines*, Amended January 1, 2018.
- 5. Engineers and Geoscientists of British Columbia, *Professional Practice Guidelines Legislated Flood Assessments in a Changing Climate in BC*, Version 2.1, dated August 28, 2018.
- 6. Engineers and Geoscientists of British Columbia, *Guidelines for Legislated Landslide Assessments for Proposed Residential Developments in BC*, dated May 2010.
- 7. Town of Ladysmith map titled "Official Community Plan, Map 1, Land Use," dated September 18, 2018.
- 8. Town of Ladysmith map titled "Official Community Plan, Map 2, Development Permit Areas," dated September 18, 2018.

## LANDSLIDE ASSESSMENT ASSURANCE STATEMENT

Notes: This statement is to be read and completed in conjunction with the Engineers and Geoscientists BC *Professional Practice Guidelines – Landslide Assessments in British Columbia* ("the guidelines") and the current *BC Building Code* (*BCBC*), and is to be provided for Landslide Assessments (not floods or flood controls), particularly those produced for the purposes of the *Land Title Act*, *Community Charter*, or *Local Government Act*. Some jurisdictions (e.g., the Fraser Valley Regional District or the Cowichan Valley Regional District) have developed more comprehensive assurance statements in collaboration with Engineers and Geoscientists BC. Where those exist, the Qualified Professional is to fill out the local version only. Defined terms are capitalized; see the Defined Terms section of the guidelines for definitions.

To:			ring Authority (or Client)	Date: September 20, 2023 File# E2668
	To	wn o	f Ladysmith	_
	410	0 Esp	olanade, PO Box 220, Ladys	mith, BC, V9G 1A2
	Juris	diction	/name and address	_
\			- VOLUTOR ONE)	
VVILI	ı reiei		O (CHECK ONE):	
7		B. Le	and Title Act (Section 86) – Subdivision ocal Government Act (Sections 919.1 ar Community Charter (Section 56) – Buildin Ion-legislated assessment	d 920) – Development Permit
		_	property (the "Property"): Road: LOT 12, DISTRICT	LOT 41, OYSTER DISTRICT, PLAN EPP119981
			address of the Property	
			. ,	
		•	,	Qualified Professional and a professional engineer or professional ence requirements as outlined in the guidelines.
	_		uthenticated, and dated, and thereby cer the guidelines. That report must be read	ified, the attached Landslide Assessment Report on the Property in in conjunction this statement.
In p	repari	ing that	t report I have:	
[CHE	CK TO	THE LE	EFT OF APPLICABLE ITEMS]	
V	1.	Collec	ted and reviewed appropriate backgroun	d information
V V	2.	Review	wed the proposed Residential Developm	ent or other development on the Property
$\checkmark$	3.	Condu	icted field work on and, if required, beyon	d the Property
V	4.	Report	ted on the results of the field work on an	I, if required, beyond the Property
$\checkmark$	5.	Consid	dered any changed conditions on and, if	required, beyond the Property
		<b>&gt;</b>	Landslide Hazard analysis or Landslide F	
		6.1		ate, any Landslide that may affect the Property
	7	6.2	estimated the Landslide Hazard	Elements at Risk on and, if required, beyond the Property
		6.4	estimated the potential Consequences	
	-		the Approving Authority has adopted a	
		7.1		adopted by the Approving Authority with the findings of my
		7.2 7.3		e Safety on the Property based on the comparison Islide Hazards and/or Landslide Risks

PROFESSIONAL PRACTICE GUIDELINES LANDSLIDE ASSESSMENTS IN BRITISH COLUMBIA

#### LANDSLIDE ASSESSMENT ASSURANCE STATEMENT

	8.	Where the Approving Authority has <b>not</b> adopted a Level of Landslide Safety, or where the Landslide Assessment is not produced in response to a legislated requirement, I have:
		, ,
	<b>V</b>	
V	9.	Reported on the requirements for future inspections of the Property and recommended who should conduct those inspections
Bas	ed on	n my comparison between:
[CHE	ECK ON	NE]
		findings from the investigation and the adopted Level of Landslide Safety (item 7.2 above) appropriate and identified provincial, national, or international guideline for Level of Landslide Safety (item 8.4 above)
		e Landslide Assessment is not produced in response to a legislated requirement, I hereby give my assurance that, the conditions¹ contained in the attached Landslide Assessment Report:
A.	SUB	BDIVISION APPROVAL
	-	subdivision approval, as required by the Land Title Act (Section 86), "the land may be used safely for the use intended" ICK ONE]
		with one or more recommended additional registered Covenants without an additional registered Covenant(s)
B.	DEV	/ELOPMENT PERMIT
	gove	a <u>development permit</u> , as required by the <i>Local Government Act</i> (Sections 488 and 491), my report will "assist the local ernment in determining what conditions or requirements it will impose under subsection (2) of [Section 491]" ICK ONE]
		with one or more recommended additional registered Covenants without an additional registered Covenant(s)
C.	BUIL	LDING PERMIT
		a <u>building permit</u> , as required by the <i>Community Charter</i> (Section 56), "the land may be used safely for the use nded"
		CK ONE]
		with one or more recommended additional registered Covenants
		without any additional registered Covenant(s)

<sup>&</sup>lt;sup>1</sup> When seismic slope stability assessments are involved, Level of Landslide Safety is considered to be a "life safety" criteria, as described in Commentary JJJ of the *National Building Code of Canada (NBC) 2015*, Structural Commentaries (User's Guide – NBC 2015: part 4 of division B). This states:

<sup>&</sup>quot;The primary objective of seismic design is to provide an acceptable level of safety for building occupants and the general public as the building responds to strong ground motion; in other words, to minimize loss of life. This implies that, although there will likely be extensive structural and non-structural damage, during the DGM (design ground motion), there is a reasonable degree of confidence that the building will not collapse, nor will its attachments break off and fall on people near the building. This performance level is termed 'extensive damage' because, although the structure may be heavily damaged and may have lost a substantial amount of its initial strength and stiffness, it retains some margin of resistance against collapse."

#### LANDSLIDE ASSESSMENT ASSURANCE STATEMENT

Chris Hudec

September 20, 2023

Name (print)

Date

1900 Boxwood Road

Address

Nanaimo, BC V9S 5Y2

(250) 756-0355

Telephone



chudec@lewkowich.com

Email

(Affix PROFESSIONAL SEAL and signature here)

The Qualified Professional, as a registrant on the roster of a registrant firm, must complete the following:

r of the firm Lewkowich Engineering Associates Ltd.

I am a member of the firm

(Print name of firm)

with Permit to Practice Number

1001802

(Print permit to practice number)

and I sign this letter on behalf of the firm.

# 2015 National Building Code Seismic Hazard Calculation

INFORMATION: Eastern Canada English (613) 995-5548 français (613) 995-0600 Facsimile (613) 992-8836 Western Canada English (250) 363-6500 Facsimile (250) 363-6565

**Site:** 48.965N 123.786W **User File Reference:** 670 Farrell Road 2023-09-20 21:42 UT

Probability of exceedance per annum	0.000404	0.001	0.0021	0.01
Probability of exceedance in 50 years	2 %	5 %	10 %	40 %
Sa (0.05)	0.581	0.420	0.309	0.137
Sa (0.1)	0.891	0.646	0.473	0.209
Sa (0.2)	1.108	0.804	0.591	0.258
Sa (0.3)	1.138	0.825	0.606	0.259
Sa (0.5)	1.030	0.734	0.526	0.214
Sa (1.0)	0.592	0.401	0.275	0.102
Sa (2.0)	0.353	0.233	0.153	0.053
Sa (5.0)	0.110	0.063	0.035	0.011
Sa (10.0)	0.039	0.022	0.012	0.004
PGA (g)	0.483	0.350	0.257	0.111
PGV (m/s)	0.748	0.509	0.353	0.130

Notes: Spectral (Sa(T), where T is the period in seconds) and peak ground acceleration (PGA) values are given in units of g (9.81 m/s²). Peak ground velocity is given in m/s. Values are for "firm ground" (NBCC2015 Site Class C, average shear wave velocity 450 m/s). NBCC2015 and CSAS6-14 values are highlighted in yellow. Three additional periods are provided - their use is discussed in the NBCC2015 Commentary. Only 2 significant figures are to be used. These values have been interpolated from a 10-km-spaced grid of points. Depending on the gradient of the nearby points, values at this location calculated directly from the hazard program may vary. More than 95 percent of interpolated values are within 2 percent of the directly calculated values.

#### References

National Building Code of Canada 2015 NRCC no. 56190; Appendix C: Table C-3, Seismic Design Data for Selected Locations in Canada

Structural Commentaries (User's Guide - NBC 2015: Part 4 of Division B) Commentary J: Design for Seismic Effects


**Geological Survey of Canada Open File 7893** Fifth Generation Seismic Hazard Model for Canada: Grid values of mean hazard to be used with the 2015 National Building Code of Canada

See the websites www.EarthquakesCanada.ca and www.nationalcodes.ca for more information







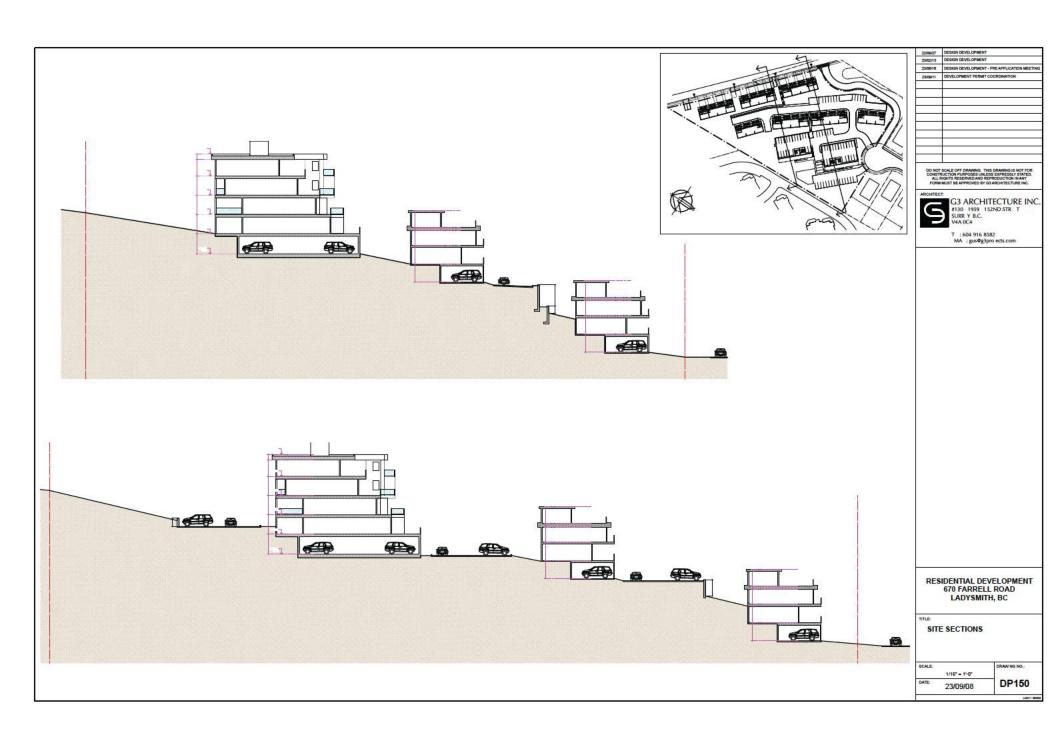



# **EA** Lewkowich Engineering Associates Ltd.

geotechnical • environmental, health & safety • materials testing

File: E2668.03

Date: February 15, 2024

#### **GEOTECHNICAL MEMO**

**Arkell Apartments** Unit 3 – 9745 Willow Street

Chemainus, BC **VOR 1KO** 

**ATTENTION:** Mr. Adam Kelln

**SUBJECT: DP 22-14 APPLICATION REVIEW RESPONSE** 

LOCATION: LOT 12, 670 FARRELL ROAD, LADYSMITH, BC

1. As requested, Lewkowich Engineering Associates Ltd. (LEA) has reviewed the project drawings and February 8th, 2024 email from the ToL planner Andrew Wilson. This memo responds to the request for additional information relating to the DPA 7 Hazard lands guidelines. The replies are detailed below:

"Location/siting of buildings and building design and their impact on slope stability and drainage based a. on review of the revised site plan".

The revised site plan includes several minor changes to the location of Civil works none of which change the conclusions and recommendations of our Geotechnical Report E2668.01r3.

b. "Driveway accesses, pedestrian walkways/footpaths, and staircases" We have reviewed the project drawings for the above items and conclude that these items will require minor manipulation of bedrock or very dense soils which will not affect the stability of the slope.

- "Landscaping and vegetation removal and any recommendations for the proposed land clearing schedule - additional comments if a phased approach is used for land clearing".
  - We do not anticipate any slope stability issues relating to land clearing, however the impermeable stratum underlying the site will create surface flows that follow the dips in the topography and ultimately exit to the lower reaches of the site (along Farrell Road). It would be prudent to have an Erosion and Sediment Control Plan (ESCP) in place prior to any clearing of trees and or removal of topsoil. A phased approach to the removal of topsoil's (stumps, low lying vegetation) will lessen the reliance and scope of the ESCP.
- d. "Review and comment on the Civil Plans for Stormwater Management and make any further recommendations"

The stormwater management plan will include detention systems that meet the project criteria as noted on the plans. We anticipate these facilities to include collected roof and hardscape areas be PROJECT: Lot 12, 670 Farrell Road, Ladysmith, BC

FILE NO.: E2668.03

DATE: February 15<sup>th</sup>, 2024



directed to detention facilities such as bioswales and oversized detention pipe galleries or other communal methodologies outside of the building footprint areas. The development area provides adequate areas for these facilities to be installed without detriment to the development or areas adjacent to the development. Specifics of this infrastructure should be completed as part of the detailed design process and reviewed prior to construction.

e. "General comments for minor alterations to the development such as installation of small accessory buildings, fences, etc. in case these need to be added in the future (a subsequent DP Amendment would not be required if this is addressed in the Geotech Report for this DP)."

Minor alterations of the slope to accommodate small accessory buildings, fences, kiosks etc will not have a significant effect to the slope stability as long as they are founded on undisturbed dense soil, rock or compacted structural fill.


2. Lewkowich Engineering Associates Ltd. appreciates the opportunity to be of service on this project. If you have any comments, or if we can be of further assistance, please contact us at your convenience.

Respectfully Yours,

**Lewkowich Engineering Associates Ltd.** 

John Hessels, AScT Senior Technologist

Chris Hudec, M.A.Sc., P.Eng. Senior Project Engineer

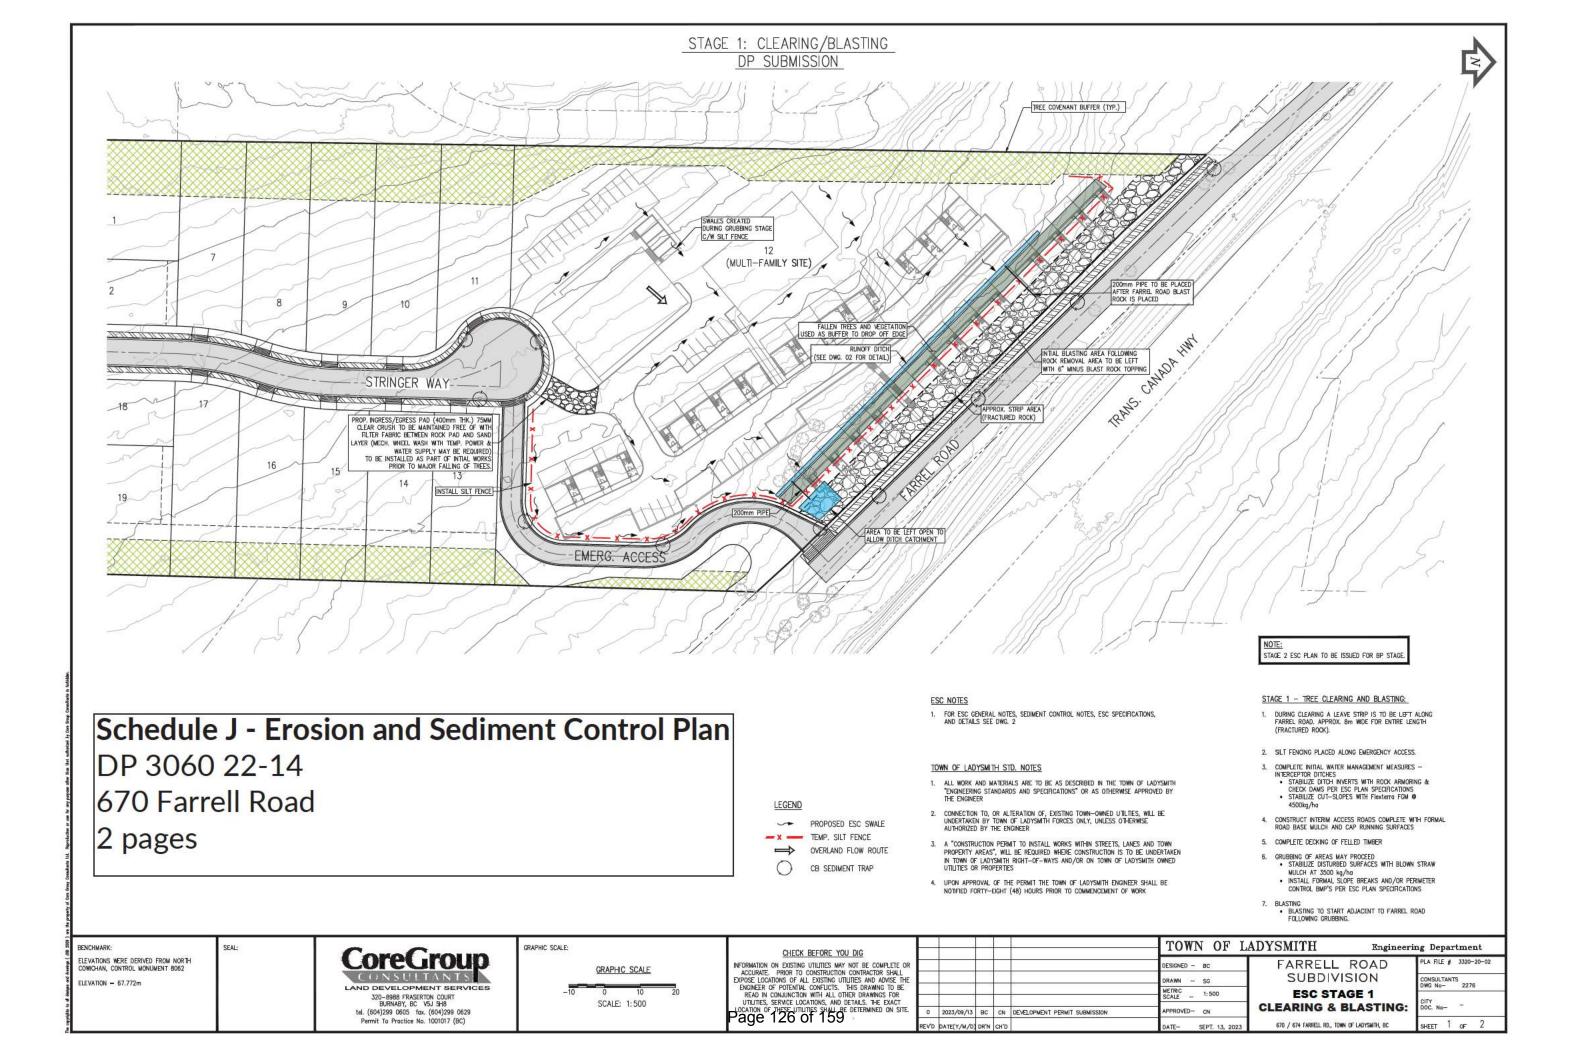


- IT IS THE CONTRACTOR'S RESPONSIBILITY TO CONSTRUCT AND MAINTAIN THE SILTATION AND EROSION CONTROL WORKS DURING CONSTRUCTION.
- ALL SILT CONTROL WORKS TO BE CONSTRUCTED PRIOR TO COMMENCEMENT OF EARTHWORKS, FOUNDATION DICKAWTION AND UNCAPPING OF THE STORM SERVICE CONNECTION CAP AND DISCHARGING INTO THE STORM SEWER SYSTEM. ADDITIONAL FACILITIES MAY BE REQUIRED, AS NECESSARY, TO CONTROL THE DISCHARGE OF SLT LADEN WATERS.
- 3. THE ONLY ACCESS TO THE SITE IS TO BE VIA THE SITE ACCESS PAO. ACCESS PAO TO BE INSTALLED PRIOR TO EARTHWORKS ACTIVITIES. ANY SILTATIOUS OR OTHER DELETERIOUS MATERIALS DEPOSITED ON THE ROADS MUST BE CLEARED UP MANEDATELY. GRAVILLAR METALLAR CURB OR SIDEMALK SHOULD BE PROPERLY COMPACTED TO A POINT AT LESSE LEVEL WITH THE TOP DEC OF THE CONCRETE IN ORDER TO PROMIDE FROM ADEQUATE SUPPORT FOR THE CURB OR SIDEMALK.
- NO SLT LADEN WATER FROM EXCAVATIONS SHALL BE PUMPED OUT OR OTHERWISE DIRECTLY. DISCHARGED TO A DITCH SYSTEM THUS BYPASSING THE SEDIMENT CONTROL FACILITIES.
- 5. ROAD MAINTENANCE CONTRACTOR MUST MAKE EVERY EFFORT TO MINIMIZE THE AMOUNT OF SOIL TRANSPORTED FROM THE SITE ONTO THE ROADWAY. THIS IS PARTICULARLY IMPORTANT WHEN ACCESSING THE SITE. THE PAYED ROAD SURFACE MUST BE REGULARLY CALENDE OF ACCUMULATIONS OF SOIL BY THE CONTRACTOR. NO SOIL, SAND OR OTHER MATERIAL WITH A HIGH SEDIMENT CONTRAIT SHALL BE DEPOSITED OR PULD OUTSIDE OF THE PROPERTY BOUNDAIRES, PARTICULARLY ON THE PAYED ROAD SURFACE. NO MATERIAL OF ANY TYPE IS TO BE DEPOSITED IN SUCH A WAY THAT IT INTERPERES WITH THE FLOW WATER ALONE THE CURBES OR INTO CATCH BASINS. ROADS SHALL BE SMEPT NOT WASHED WITH WATER DIRECTED TO STORM SEWER.
- DISTURBED SOILS WHICH WILL BE LEFT "AS-IS" FOR MORE THAN 30 DAYS WILL BE MULCHED, SEEDED OR OTHERWISE EROSION CONTROLLED ON A SEMI-PERMANENT BASIS.
- ALL EARTHWORKS TO BE CARRIED OUT IN DRY WEATHER, PREFERABLY BETWEEN MAY & SEPTEMBER. CONTRACTOR TO SUSPEND EARTHWORKS OPERATIONS DURING HEAVY RAINFALL EVENTS.
- ESC DWGS. HAVE BEEN REMEMBED AND ACCEPTED BY THE ENVIRONMENTAL CONSULTANT. ALL ESC WORKS WILL BE UNDER THE DIRECTION OF THE ENVIRONMENTAL MONTOR.

#### SEDIMENT CONTROL NOTES:


- DEVELOPER'S CONTRACTOR SHALL BE RESPONSIBLE TO PROVIDE SITE SLITATION CONTROL AS NECESSARY TO PROVENT THE RELEASE OF SLT LABEN WATERS FROM ENTERING ANY STORM SEWER AND DITCH STSTEED.
- DEVELOPER'S CONTRACTOR TO INSTALL TEMPORARY SITE SILTATION CONTROL TRAPS AT EACH CATCHBASIN WHICH ACCEPTS ANY SILT LADEN WATERS.
- DEVELOPER'S CONTRACTOR TO INSTALL TEMPORARY GRAVEL BERM OR SILT FENCE BESIDE ALL CURB & GUTTER AREAS PRIOR TO EARTHWORKS ACTIVITY.
- DEVELOPER'S CONTRACTOR TO PROPERLY INSTALL, TEMPORARY SILT FENCE AROUND ALL STOCKPILES OR UNIVEGETATED FILL AREAS.
- DEVELOPER'S CONTRACTOR TO INSTALL SLOPE BREAKS PER PLAN SPECIFICATIONS AND/OR AT MIN. 30m SLOPE LENGTH SPACING.
- 6. DEVELOPER'S CONTRACTOR TO MAINTAIN SITE SILTATION CONTROL TRAPS AS NECESSARY TO ENSURE PROPER OPERATION LUTL ALL CHIL CONSTRUCTION FOR LOTS IS COMPLETED. AT TIME OF FINAL INSPECTION, CONTRACTOR TO CAP PIPE LEDGS TO CACTEBASINS AND NFILL TRAPS, SHALES AND TO INSTALL ASPHALT CATCH BASIN SEDIMENT TRAPS.
- DEVELOPER'S CONTRACTOR TO REMOVE SILT FROM ASPHALT CATCH BASIN SEDIMENT TRAPS ON A REDULAR AND AS-NEEDED BASIS UNIT. THE EBUT OF THE MAINTENANCE PERIOD OR UNTIL 90% OF LIDTS HAVE BERS BUILT ON, WHICHEVER OCCURS LATER.
- SITE DISCHARGE TO BE LIMITED TO 25 NTU AFTER NON—SIGNFICANT & 75 NTU AFTER SIGNFICANT RAINFALL EVENTS WHEN PERMIT ISSUED.
- EXPOSED SLOPES TO BE COVERED IN POLY PLASTIC IMMEDIATELY TO PREVENT CREATION OF SILT-LADEN RUNGET, PERMANENT (AND TEMPORARY SLOPES TO BE LEFT FOR MORE THAN 30 DAYS WITHIN THE GROWING SEASON (PRIOR TO SEPTEMBER 15)) TO BE SEEDED AND COVERED WITH STRAW AT A MINIMUM RATE OF 5,000kg/ha.
- 10. HALOKLEAR BELT OR APPROVED EQUAL TO BE STORED ON SITE AT ALL TIMES. THIS SHOULD BE IMPLEMENTED WITHIN OWSTRE DITCHES TO TREAT SITE RUMOFF PRIOR TO ENTRY TO SEDIMENT CONTROL FACILITIES TO PROVIDE "PRE-TREATMENT" AND AUGMENT SCS PERFORMANCE.
- CONTRACTOR TO ENSURE ALL ROADS ADJOINING THE SITE ARE TO BE KEPT CLEAN AND FREE OF DEBRIS. —VACUUM SWEPT (NOT FLUSHED).


#### STAGE 1 - SITE CLEARING PHASE

- PRIOR TO ANY CLEARING OR DICAVATION, THE SITE CONTRACTOR SHALL INSTALL SLT FENCE AROUND THE PERMICER OF THE WORK AREA AS SHOWN TO PREVENT ACCESS TO UNDISTURDED AREA (AS APPLICABLE).
- PRIOR TO SITE STRIPPING AND EXCAVATION, SILTATION CONTROL SWALES COMPLETE WITH DRAIN ROCK CHECK DAMS SHALL BE INSTALLED WHERE APPLICABLE

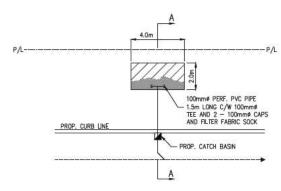

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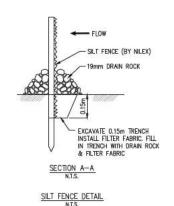


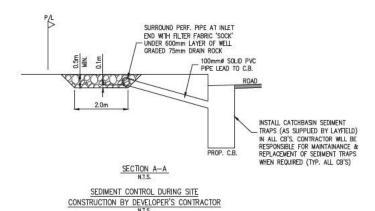
INGRESS/EGRESS ROCK ACCESS PAD DETAIL

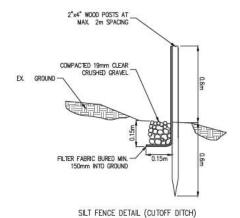- SHOWN ON DWG.

75mm CLEAR CRUSHED ROCK (EXTENT & THICKNESS PER PLAN VIEW CALLOUT) c/w
-FILTER FABRIC PER NILEX 4535 (OR APPROVED EQUIVALENT) BETWEEN ROCK & SUBGRADE

FILTER FABRIC PER



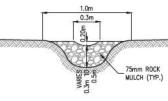

CUTOFF DITCH CHECK DAM / GRAVEL BERM SECTION
W/ SMALL NOTCH FOR GREATER RAINFALL EVENTS NOT TO SCALE

CUT OFF DITCH TO BE LINED WITH 10 MIL POLY PLASTIC POND LINER OR APPROVED EQUIVALENT

75mm ROCK MULCH (TYP.) TOE OF UPHILL BERM TO BE 10cm BELOW TOP OF DOWNHILL BERM


CUTOFF DITCH

CHECK DAM / GRAVEL BERM PROFILE

(SHOWN THROUGH CENTRE OF BERMS)

NOT TO SCALE

- SWALE INVERT

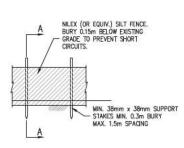

SILT FENCE PROFILE @ STORM CONNECTION N.T.S.

ROCK BERM TO BE LOCATED AS DIRECTED BY THE ENGINEER OF RECORD, NO SILT LADEN WATER TO LEAVE SITE.

ELEVATION = 67.772m

ELEVATIONS WERE DERIVED FROM NORTH COWICHAN, CONTROL MONUMENT 8062

**CoreGroup** CONSULTANTS LAND DEVELOPMENT SERVICES 320-8988 FRASERTON COURT BURNABY, BC V5J 5H8

Permit To Practice No. 1001017 (BC)

GRAPHIC SCALE SCALE: 1:1000 tel. (604)299 0605 fax. (604)299 0629

CHECK BEFORE YOU DIG INFORMATION ON EXISTING UTILITIES MAY NOT BE COMPLETE OR ACCURATE. PRIOR TO CONSTRUCTION CONTRACTOR SHALL EXPOSE LOCATIONS OF ALL EXISTING UTILITIES AND ADVISE THE ENGINEER OF POTENTIAL CONFLICTS. THIS DRAWNO TO BE ENGINEER OF PICTURE DE CONTROL DE LA CONTROL Page 127 of 159

TOWN OF LADYSMITH ESIGNED - BC DRAWN - SG METRIC \_ 1:1000 PROVED- CN 0 2023/09/13 BC CN DEVELOPMENT PERMIT SUBMISSION

Engineering Department FARRELL ROAD SUBDIVISION **ESC PLAN NOTES & DETAILS** 

670 / 674 FARRELL RD., TOWN OF LADYSWITH, BC

ONSULTANTS WG No- 2276 HEET 2 OF



January 29, 2024

Robyn Kelln 2188 North End Road Salt Spring Island BC V8K 1E1 Schedule K - Bird Nesting Report DP 3060 22-14 670 Farrell Road 3 pages

Via Email: robynkelln@yahoo.com

MEMO: 670 FARRELL ROAD LADYSMITH BC CLEARING PHASE

Aquaparian Environmental Consulting Ltd (Aquaparian) was retained to provide comments for proposed clearing of a stand of second growth forest within a parcel located at the end of Farrell Road in Ladysmith BC. The parcel is proposed to be developed as a residential subdivision. As understood, the parcel is under construction and nearing the end of permitting submissions for lot development.

Birds are protected by the following federal and provincial Acts:

Federal Migratory Birds Convention Act, 1994. Most species of birds in Canada are protected under this act. "Migratory birds" are defined by Article I of the Convention which names the families and sub-families of birds protected, and provides some clarification of the species included. In general, birds not falling under federal jurisdiction within Canada include grouse, quail, pheasants, ptarmigan, hawks, owls, eagles, falcons, cormorants, pelicans, crows, jays, kingfishers, and some species of blackbirds. Timing for vegetation clearing will be provided in the recommendations section to avoid impacts to migratory birds.

**Section 34 of the Provincial** *Wildlife Act*, states that a person commits an offence if the person, except as provided by regulation, possesses, takes, injures, molests or destroys:

- (a) a bird or its egg,
- (b) the nest of an eagle, peregrine falcon, gyrfalcon, osprey, heron or burrowing owl, or
- (c) the nest of a bird not referred to in paragraph (b) when the nest is occupied by a bird or its egg.

A brief walk through the site did not identify any trees within or in proximity of the subject parcel that would be suitable for an eagle or heron nest. Other forest bird species are expected to utilize the parcel for nesting during the breeding season.

Environment and Climate Change Canda identifies the Vancouver Island and lower mainland as Zone A1 to provide general nesting season guidelines for migratory birds. For forested habitat, the general guideline for the nesting season is March 15<sup>th</sup> to August 15<sup>th</sup>. However, some municipalities have adopted their own guidelines typically from March 1<sup>st</sup> to August 31<sup>st</sup> to capture seasonal variation. For example, if the warm spring weather arrives earlier than normal, migratory birds can start their breeding cycle a little earlier than typical. Similarly, if the spring season starts late, some breeding may be delayed, or if there is poor weather in the middle of the season, a second clutch of eggs may be laid later in the season.

Best Management Practices recommends that vegetation clearing be completed outside of the migratory bird nesting season to avoid direct or indirect (disturbance) to nesting birds. During the nesting season, it is not recommended to clear during the peak season (May 1 – July 15). It may be possible to clear vegetation either early in the season or late in the season, but a suitably qualified environmental professional is required to complete a nesting survey within a few days of proposed clearing. If an active nest is discovered, a no-disturbance buffer is delineated and the nest is checked again, sometimes repeatedly, until fledging has been confirmed. This results in additional cost and project delays.

This year appears to be unusually warm and may result in an early spring season. As such Aquaparian recommends that clearing should be completed prior to March 1<sup>st</sup> if it is possible, and no later than March 15th. After that date, a pre-clearing nest assessment will be required.

If you have any questions or require further information, please contact the undersigned.

#### Sincerely,

#### AQUAPARIAN ENVIRONMENTAL CONSULTING LTD




Sarah Bonar B.SC., R.P.Bio

Senior Biologist / Principal.

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# SITE LOCATION MAP





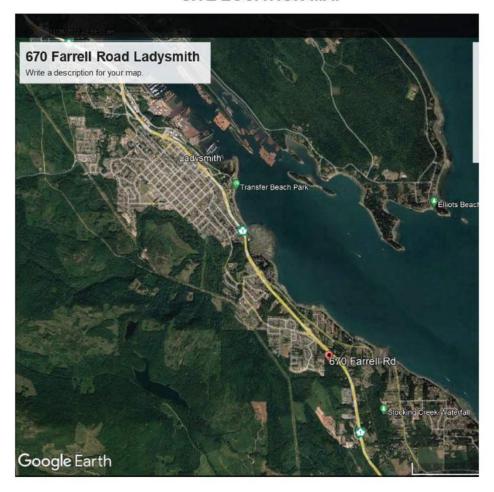



NOTE: THIS RENDERING IS FOR REPERENCE CHLY WITH REGARDS TO BUILDING WASSAND SITE LAYOUT. THEY DO NOT REPLECT EXACTLY THE FIRIAL DESIGN, REPER ALSO TO BUILDING ELEVATIONS, FINISH SCHEDULES AND OTHER RECHECTURAL DIMARMINGS AND LANGICAPE FOR FIRIAL DESIGN AND PROPOSED DETAILS.

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G3 ARCHITECTURE INC #130 - 1959 - 152ND STREET SURREY, B.C. V4A 0C4

TEL; 604-916-8582 EMAIL: gus@glprojects.com

THE ARKELL
RESIDENTIAL DEVELOPMENT
670 FARRELL ROAD
LADYSMITH, BC
DEVELOPMENT PERMIT #0P22-14

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> TEL; 604-916-8582 EMAIL: gus@g3projects.com

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TEL: 604-916-8582 EMAIL: gus/g3projects.com

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# **ATTACHMENT D - Conceptual Renderings**





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LADYSMITH, BC
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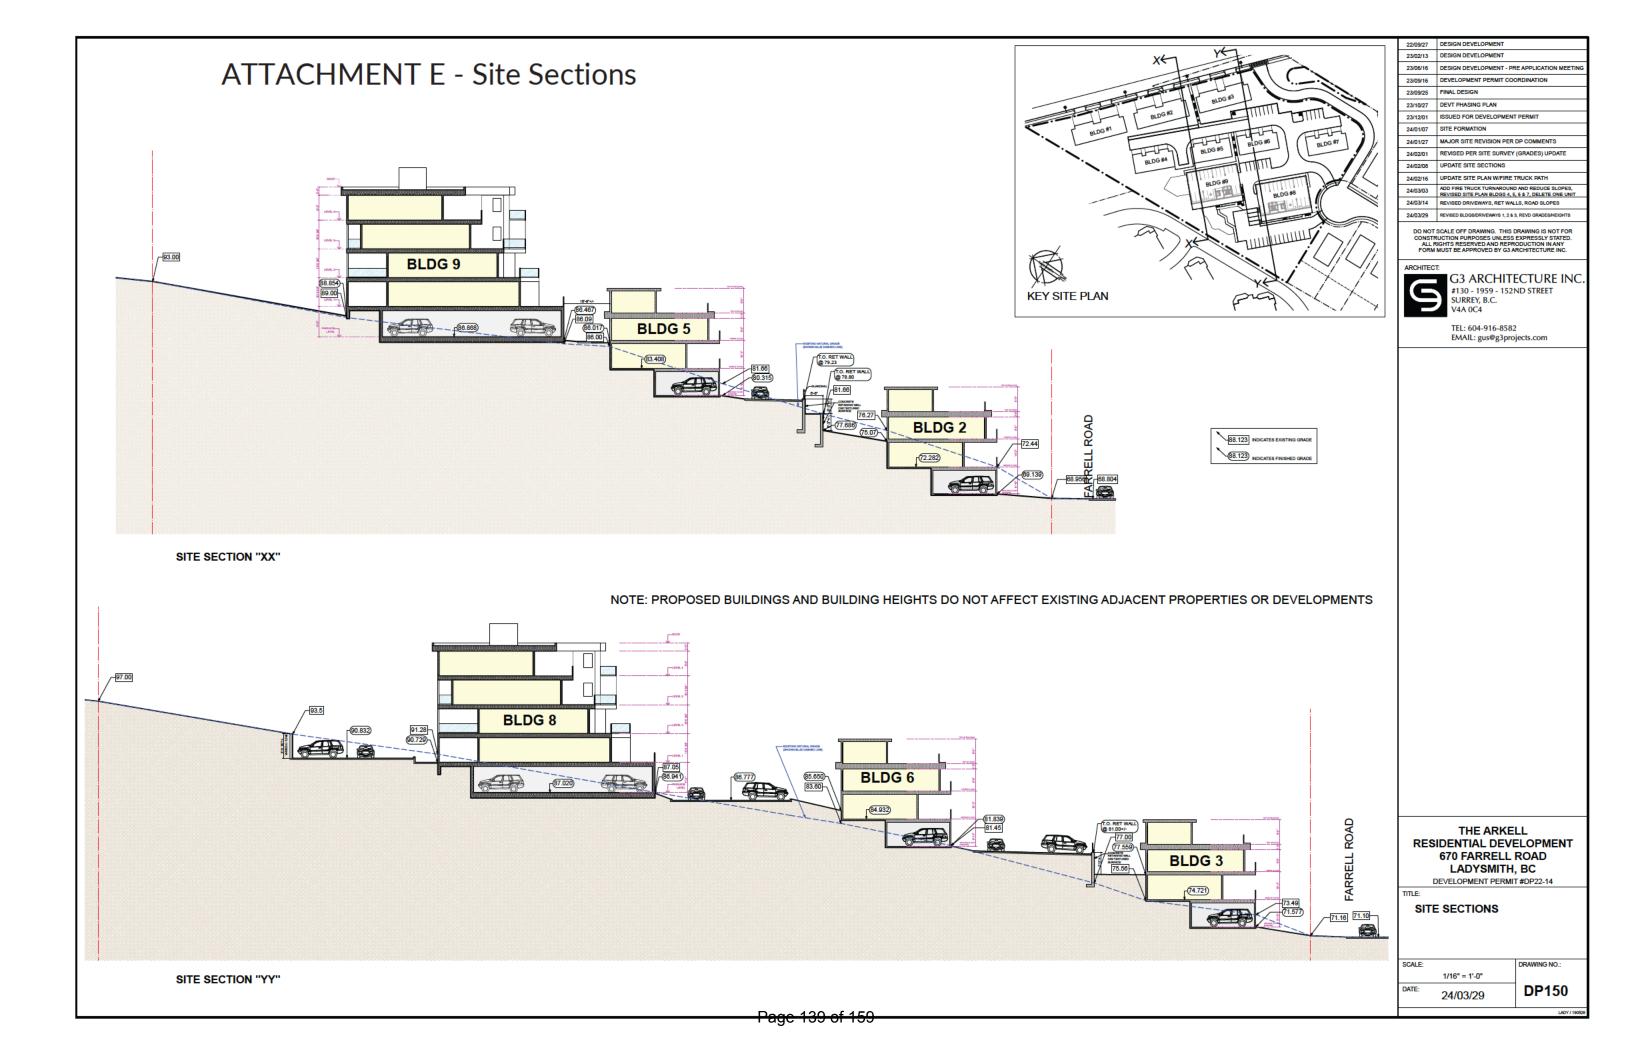
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# ATTACHMENT F

March 29, 2024

Attn: Andrew Wilson
Planner
Development Services Department
Town of Ladysmith
132C Roberts Street - Box 220
Ladysmith, BC V9G 1A2

DP# 22-14

RE RATIONALE LETTER AND PROJECT SUMMARY (REVISED FEB 8/24) 24 UNIT TOWNHOMES AND 30 UNIT APARTMENT BUILDINGS AT 670 FARRELL ROAD, LADYSMITH, BC

#### PROJECT SUMMARY AND DESIGN RATIONALE:

The 3.6 acre subject property is situated at the north end of an overall 12 acre single family and multi family subdivision. The property fronts Farrell Road to the north and extends southerly approx. 500ft up a steep slope.

At the top of the site (south end) there is a new road and cul-de-sac providing vehicular access down into the site. A new emergency access road has been developed along the east side of the property connecting Farrell Road up to the new cul-de-sac. There is a dedicated environmental setback along the west side of the subject property.

The existing property is undeveloped and is characterized by trees and rock outcrops. The surrounding properties contain a mix of single and duplex family oriented dwellings. The subject property slopes steeply downward approximately 23+/-m from south to north and a downward cross-slope (east to west).

#### PROPOSED DEVELOPMENT:

The proposal is to construct 3 x 4-plex townhouses, 4 x 3-plex townhouses = 24 multi-family townhouse units and 2 x 4-storey apartment buildings each containing 15 dwelling units = 30 apartment units for a total of 54 dwelling units on the subject site.

Each typical townhouse unit is approximately 1,800 sf, 3-storeys, 3 bedrooms and double wide garage. There are a variety of apartment units ranging from 1 bedroom units of 1,000+/-sf to 3 bedroom units of 1,650+/-sf.

The maximum floor area allowed at 0.66 FAR = 105,764sf and the total proposed net floor area = 82,928sf (FAR = 0.52). The total proposed site coverage is 26.8% which is less than the maximum allowable 33.0%.

#### SITE DESIGN:

Along Farrell Road there are 3 x 4-plex townhouse buildings with doubled up driveways (approx. 8% sloped) for each unit directly from Farrell Road. Due to the existing steep site topography vechicular access from Farrell Road to the remaining townhomes (at mid level) and the apartment buildings can only be achieved from the top of the site at the south end from the cul-de-sac. However there is a pedestrian connection from Farrell Road upto through the entire site accessing the entire development.

New retaining walls approx. no higher than 10ft (3.0M) are to be constructed behind the first row of townhouses along Farrell Road (at mid level) to accommodate a private road and to locate the remaining 12 townhouse units and outdoor amenity areas. The two 4-storey apartment buildings are at the top of the site, stepped into the slope and incorporate underground parking. All townhouse units and apartment units enjoy magnificent views and plenty of surrounding open space including very large outdoor balconies and roof top patios promoting green roofs and providing a pleasant

LADY / 190528 page 1 / 3

foreground for units at higher topographies looking over the buildings in front. The proposed building locations, massing and building heights do not compromise the views of any adjacent properties.

In accordance with Steep Slope Design practices, all the buildings are located in a way that minimizes the disturbance of natural features on the site and minimizes shadows, while optimizing views, daylight exposure and functionality.

Shared driveways directly off of Farrell Road give access to the at-grade garages of each unit. Each townhouse provides 2 indoor parking stalls, side by side in attached garages. The proposed total number of parking stalls meet the minimum number of "Off Street Parking" requirements per the Town of Ladysmith Zoning Bylaw 2014 - Part 8. Accessible/Handicap parking stalls, visitor parking stalls and bicycle spaces are provided throughout and pedestrian connections are provided from the front doors of each unit to the drive aisles. EV charging for both vehicles and bikes will be provided as required.

In addition to the large outdoor private balconies and outdoor roof top patios there are several developed communal outdoor amenity spaces serving both the townhouses and apartment buildings conveniently located in a safe location.

Garbage and recycling receptacles will be stored within the garages of each townhouse unit with centralized garbage and recycling for the apartment buildings. Long term bicycle parking is provided in each and every garage for each townhouse and one space for each dwelling unit in the Apartment buildings. Short term bicycle parking racks are provided throughout the site and as required.

#### **BUILDING DESIGN:**

#### Townhouses:

All townhouse buildings are 3 storey at the front and 1 storey at the rear due to the grade change and steep slope. The lowest level (garages) are only 1/2 the depth of the above floors to minimize the volume of excavation required and respecting the natural site topographic constraints. All the front facades are well articulated with the building massing and placement of front entries and garages clearly identifying individual units. The building forms are accentuated with large overhangs along with decorative timber columns. Each floor has an outdoor balcony (2 per unit) providing favorable street front surveillance and taking advantage of desirable views from that level and orientation. Additionally there are developed roof top patios providing ample outdoor space for lounging, views, herb gardens, hot tubs, etc...These roof top patios also provide a pleasant foreground for the units located behind and above as oppose to blank inanimate roofs. The varied use of durable exterior finishes strategically placed creates a warm and inviting residential facade accentuating the architectural character. The subtle color variation in exterior finishes from unit to unit provide a sense of individuality and artistic rhythm while preserving the design continuity. Windows and doors have been accentuated with trims and contrasting colors and noise reducing glazing will be used for windows facing Farrell Road.

#### Apartment Buildings:

Each and every apartment unit boasts a large outdoor balcony facing the uninterrupted ocean views. There is direct access to the "outdoor" common hallways, lobby and elevator from the underground parkade and from the outdoor parking areas. The "outdoor" exit stairwells, common hallways, etc... provide abundant natural light and minimize life cycle costs such as heating/cooling and maintenance. All the apartment units enjoy panoramic ocean views with maximum sized windows. The north orientation of the large glazed areas minimize solar gain. The underground parkades are only half below grade and allow for plenty of natural ventilation and secured parking. A ground floor oriented and secure bike storage locker room is provided to encourage the use of bikes in lieu of vehicle dependency. Centralized and enclosed communal garbage and recycling is provided at the parkade level. The use of dark red brick veneer, white horizontal lap siding and ornamental fascia details accentuate the horizontal massing while creating a proud traditional residential feel to the buildings, complementing the townhouses below. All entires to the individual apartment units are "recessed". A decorative cantilevered steel/glass canopy is located above the main floor entry to the building "lobby" area.

In general the proposed development incorporates several design concepts and initiatives intended to address the goals of reducing green house gas and promote energy and water conservation. The orientation of the buildings combined with the location of windows and floor plan layouts mitigate solar gain, promote the use of natural ventilation and natural daylight to the interior spaces, minimizes shadows and the disturbance of natural features on the site. The proposed building scale, character and exterior finishes complement the existing character of adjacent newer developments for continuity and to integrate the colors and textures of the natural surroundings. Furthermore the exterior finishes (prefinished aluminum siding, cementitious composite siding, local douglas fir posts, etc...) and colors have been chosen to minimize heat absorption and incorporate low-carbon and low maintenance properties.

LADY / 190528 page 2 / 3

The building is intended to be constructed with sustainable building materials, using conventional wood frame methodology, high performance windows and doors, optimization of the building envelope, efficient construction management/scheduling/delivery methods, and a concerted effort to the recycling of construction waste to reduce landfill use. Interior finishes include the use of low VOC materials, materials that are recycled, reused and renewable or contain recycled materials (where possible), energy efficient appliances and equipment, low consumption fixtures, etc... Heat pumps and accommodations (conduits) for future on site solar photovoltaic energy collection are to be explored for feasible integration.

Both interior and exterior lighting specifications shall be energy efficient, such as LED and incorporate timers, photovoltaic sensors and motion sensors where possible to provide lighting only when required. The proposed landscape lighting and general outdoor lighting will implement shields and fixture locations to reduce glare and light pollution. Electrical charging stations and/or electrical rough-in (40 amp) at designated parking areas shall be provided

The building is intended to be constructed with sustainable building materials, using conventional wood frame methodology, high performance windows and doors, optimization of the building envelope, efficient construction management/scheduling/delivery methods, and a concerted effort to the recycling of construction waste to reduce landfill use. Interior finishes include the use of low VOC materials, materials that are recycled, reused and renewable or contain recycled materials (where possible), energy efficient appliances and equipment, low consumption fixtures, etc... Heat pumps and accommodations (conduits) for future on site solar photovoltaic energy collection are to be explored for feasible integration. The apartment buildings will be constructed under Part 3 of the BC Building Code complete with sprinkler fire protection. The townhome buildings are to be constructed under Part 9 of the BC Building Code. The site plan, locations of buildings and exterior fenestration have incorporated the anticipated fire response times to the subject site as well as spatial separation and limiting distance constraints to conform the building code requirements.

#### PROPOSED VARIANCES:

Variances between 0.58M up to 2.00M to the maximum allowable building height of 10.0m are proposed for the 3 out of the total 7 townhouse buildings at mid site due to the steep slope conditions and utilizing the lowest average grade calculations. In order to achieve the original subdivision proposed density for this site and combined with the topographical challenges and preservation efforts of natural site area "apartment' style multi-unit multi-storey buildings are required to provide an adequate number of dwelling units. As such, the proposed heights of the apartment buildings require upto 5.18M and 6.26M respectively above the maximum 10.0M height in order to achieve the density. The proposed building heights allow the overall project to accommodate the significant site slope/topography with the least amount of site impact, permit more than 50% of the required parking to be "under" the building, while preserving the functional layouts of residential units, safe vehicular circulation and project feasibility. Furthermore the proposed building heights do not impede any adjacent properties due to the site topographies of the adjacent properties and the developments there upon.

#### PHASED DEVELOPMENT:

The overall site preparation, land clearing and excavation is to be all undertaken this spring (2024) in advance of the bird nesting season. However, the overall project development and construction of the buildings themselves and roads are to be scheduled into FIVE (5) phases under 5 separate building permits. The first phase to include 8 townhouse units, Buildings #1 & #2 located along Farrell Road, followed by the remaining 4 townhouse units, Building #3 on Farrell Road completing Phase 2. Phase 3 will follow with construction of 6 townhouse units, Buildings #4 & #5, then Phase 4 with the remaining 6 townhouse units. Phase 5 will be the construction of the two apartment buildings #8 & #9 totaling 30 units. ERED ARCH

**End** 

Gustavo da Roza III B.Sc., M.Arch, MRAIS, NOARB

Architect - AIBC, MAA

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# ATTACHMENT G

#### **REVIEW OF DPA GUIDELINES**

### DPA 4 - Multi-Unit Residential

The following tables provide a summary of the consistency of the proposal for 670 Farrell Road with the Development Permit Area 4 – Multi-Unit Residential and Development Permit Area 7 – Hazard Lands.

Table A. summarizes the analysis of the applicant's proposal against the DPA 4 guidelines.

Table 1: Summary of DPA 4 Multi-Unit Residential guidelines and staff comments.

DPA 4 Guidelines	Staff Comments
1. Building Design	
Scale/neighbourhood identity	• The architectural theme and massing of the proposed buildings complement residential buildings in the neighbourhood.
Exterior design aesthetics, materials, and colours	<ul> <li>Building facades are articulated by the use of varying materials, finishes, balconies and rooflines.</li> <li>Three exterior finish schemes are proposed for the townhouses which show a variation in stone accents and siding colour. Douglas fir timber accents create an aesthetically pleasing visual contrast for all townhouses.</li> </ul>
Design aesthetic of neo-traditional,	The proposal uses some neo-traditional contemporary
Pacific Northwest, or eco-	elements. The townhouses are accented with decorative
responsive themes	timber columns.
Resembles single unit dwellings	• The townhouse building facades are well articulated and individual units are clearly identified.
Variation in building designs	<ul> <li>The townhouse building facades are articulated by varying colours and stonework on the facades.</li> <li>The proponent has elected to have both apartment buildings appear as one project utilizing the same design for overall design integrity and consistency.</li> </ul>
2. Building Siting and Massing	
Height and massing variation and roofline treatments between buildings	• The proponent has applied for a DVP to vary the height of townhouse Buildings 4, 6, and 7 and multi-family buildings 8 and 9.
	• There is no variation in massing and height proposed. Buildings are uniform in design. The topography of the land and siting of buildings creates a variation in building height elevations.
Multi-storey buildings setback and	The 2nd and 4th storeys of the proposed apartment
terraced above 3 <sup>rd</sup> level	buildings are stepped back at the front.
Building design stepped with	Although there are retaining walls proposed, the site plan
topography, nestled into hillside,	was designed to make use of the existing topography
with cuts and fills blending with the	without significant cuts and fills.
topography	• Townhouse buildings are 3 storey at the front and 1
	storey at the rear due to the grade change and slope

Passive heating/cooling from	Tree planting of deciduous trees is proposed on South		
landscaping	elevations. The Landscape Plan is a condition of the DP.		
3. Building Frontages			
Building frontages articulated and	Townhouse buildings are articulated horizontally by steps		
visually broken-up	and broken up into smaller, distinctive units through the		
, ,	use of varying colour schemes.		
Facades modulated through design	Building step-backs, changes in façade materials, and		
methods	proposed window penetrations contribute to a modulated		
	design.		
Orientation towards street	The proposed buildings are all oriented towards Farrell		
	Road.		
Streetscapes and building facades	• The proposed townhouses have front garages. Access		
are not dominated by garage	from the rear is not practical given the topography of the		
	property. Design articulation provides visual interest not		
4 Doof Form	dominated by the garages.		
4. Roof Form Sloping roof forms encouraged.	Flat roofs are proposed for all buildings so not to increase		
Sloping roof forms encouraged.	vertical massing of the stair towers. Slope roofs were		
	considered, however, this would effectively increase the		
	height variance required.		
Roofline modulation to provide	Rooftop patios on townhouses provide visual interest.		
visual interest	, , , , , , , , , , , , , , , , , , ,		
5. Windows & Doors			
Building entrances are clearly	Apartment building entrances are defined by special		
defined. Townhouses have	paving, landscaping, furnishing and lighting.		
separate, street-oriented entrances	Townhouses have separate entrances with strong unit		
and recessed doorways	identity and recessed doorways.		
Windows are architecturally	Windows are complimentary to the design of the		
compatible with building	buildings and are accentuated with trims and contrasting		
	colours.		
6. Signs, Canopies & Lighting			
Compatible signage	Any signage will require a sign permit.		
Canopies or other building	The main floor entrances for the apartment buildings are		
projections should provide weather	recessed and covered and do not require additional		
protection	canopies or projections.		
Adequate lighting to illuminate	Lighting is proposed in the landscape plan including		
sidewalk areas adjacent to buildings	pedestrian pole lights for paths and walkways and street pole lights for illuminating the laneways.		
Light fixtures should be concealed	Outdoor lighting fixtures are not concealed as per the		
	guidelines, however the fixture design complements the		
	overall project aesthetics.		
Exterior lighting should follow dark	Outdoor lighting will use shields and fixture locations to		
sky principles	reduce glare and light pollution.		
7. Liveability			
Visual privacy of interior living	Privacy has been considered in site plan and interior		
maintained	layouts.		
Building and site design to mitigate	Windows in the townhouses facing Farrell Road are     Proposed to have poice reducing glazing.		
noise impacts of roads and highways	proposed to have noise reducing glazing.		

Private outdoor living spaces should • All buildings are designed so each dwelling unit has an be provided for each dwelling unit outdoor balcony. • Townhomes include a roof top patio to provide ample outdoor space. Shared amenities for the property are proposed to include play equipment, fitness area, dining terrace, casual seating, and viewpoints with games tables. 8. Materials & Colours Building materials should be durable Apartment buildings design includes wood-look light and high quality and cohesive with grey hardiplank siding and red brick veneer. Grey doors neighbourhood provide variation to the colour palette. • Three townhome design schemes are proposed for the exterior finishes with a variation of colours of board and batten hardie panel, longboard wood-look aluminum siding, and cultured stone cladding around the garage doors. Douglas fir timber accents are used for all townhomes. 9. Mechanical, Electrical & Security Equipment Mechanical equipment should be • Rooftop and at-grade equipment is screened with high strategically located and screened. quality durable materials. Air vents and other exterior mechanical and electrical components is located away from adjacent buildings and outdoor amenities and screened from view. 10. Accessibility & Connectivity Building and sites should be Townhomes have stairs and are less accessible. designed to be accessible to all Multi-unit buildings have accessible entrances at ground users. level and to the underground parking. Accessibility throughout all the common areas is provided and typical unit layouts including hallways, doors, bathrooms, and kitchens can accommodate elderly, children and people with disabilities. Public walkways and entrances Pedestrian connections run through the centre of the site should provide and across the site to amenity areas. Walkways connect all seamless. functional, and safe pedestrian buildings from Farrell Road to Stringer Way. network. • The emergency access road is blocked to traffic with the use of bollards and provides an additional pedestrian corridor. · A fully accessible pathway through the site is not provided due to topography constraints. 11. Vehicle & Bicycle Parking Vehicle parking should be located to • Street fronting parking along Farrell Road is preferable for the rear or side of buildings. Street limiting excavation due to the topography and slope of the fronting parking entries, carports, or garage doors are discouraged. Underground parking is provided for both apartment buildings. Shared vehicle access and shared • Shared visitor parking areas are provided for townhouse buildings 4, 5, 6, and 7 and for both apartment buildings. surface parking areas is encouraged. Surface parking areas should • Surface materials proposed include pavers for the delineate driving, parking, and sidewalk, asphalt road, and decorative permeable pavers pedestrian area though the use of for the visitor parking areas.

materials, colours, and patterns.	<ul> <li>Landscaping is provided around all parking areas.</li> </ul>
Parking areas should be visually	
enhanced with landscaping.	
Off-street parking spaces shall be	• The proposal includes 10 electric vehicle charging stalls.
equipped with one set of electric	6 electric vehicle charging stalls are required for the 120
vehicle charging equipment per 20	parking spaces as per the guidelines.
spaces.	
Bicycle parking should be provided	• 14 short-term and 54 long-term bicycle spaces are
for every building.	proposed for the development as follows:
	o 6 short-term and 24 long-term bicycle spaces are
	proposed for the townhouses.
	o 4 short-term and 15 long-term bicycle spaces are
	proposed for each multi-family building
	Long-term bicycle parking spaces in multi-family
	buildings 8 and 9 are located close to elevators and access
	point.
	Visitor bicycle parking is proposed in highly visible
	locations.
Parking areas, driveways and	• There is ample permeable surface space and stormwater
walkways should have adequate	drainage system adjacent to paved surfaces for snow
areas for snow storage and drainage.	storage. Lawn areas are available for snow storage.
12. Landscape	
Site planning should be guided by	• No existing trees or shrubs are proposed to be retained.
the preservation of existing trees,	Conifers in the 10m tree buffer area along the western
shrubs, groundcover, and other	property boundary are to be removed as per wildlife
natural features.	covenant.
Disturbed natural areas should be	• Disturbed areas are to be replanted with native trees,
restored to replicate the natural	grass and wildflowers, and drought tolerant shrubs as per
setting.	the Landscape Plan.
Front yard not used for access	All front yard areas will be landscaped.
should be landscaped.	
Only lawn should not be supported.	Proposed lawn areas are enhanced with landscaped
	ground cover, shrubs, and trees.
Retaining walls should be terraced	Stepped retaining walls incorporate landscaping between
or stepped and plant material	the steps.
incorporated into the wall design.	
Concrete retaining walls should	Proposed retaining walls include textured concrete as per
include textured concrete on the	the guidelines.
face of the wall. Untreated large	
concrete and concrete block walls	
are not supported.	
I Design and make violations of in females	
Design and materials used in fences	Fencing and retaining wall design is complementary to
and retaining walls should	the site design. High quality commercial grade aluminum
and retaining walls should complement the building design and	
and retaining walls should complement the building design and neighbourhood character.	the site design. High quality commercial grade aluminum fencing is proposed.
and retaining walls should complement the building design and neighbourhood character.  Surface parking and storage areas	the site design. High quality commercial grade aluminum fencing is proposed.  • Surface parking and storage areas are screened with
and retaining walls should complement the building design and neighbourhood character.  Surface parking and storage areas should be screened.	the site design. High quality commercial grade aluminum fencing is proposed.  • Surface parking and storage areas are screened with trees and shrubs.
and retaining walls should complement the building design and neighbourhood character.  Surface parking and storage areas should be screened.  Multi-purpose landscapes,	the site design. High quality commercial grade aluminum fencing is proposed.  • Surface parking and storage areas are screened with trees and shrubs.  • Shade trees and multi-purpose seating including boulder
and retaining walls should complement the building design and neighbourhood character.  Surface parking and storage areas should be screened.	the site design. High quality commercial grade aluminum fencing is proposed.  • Surface parking and storage areas are screened with trees and shrubs.

L	The leadern along to community and timite the com-
Landscaped roofs are encouraged.	• The landscape plan is comprehensive and limits the use
	of lawn areas.
Landscape groundcover plants	Bark or other combustible mulch is not proposed.
should be used rather than	Artificial turf is not proposed as per the guidelines.
extensive mulch or gravel. Use of	
artificial turf should not be	
supported.	
Use native, drought tolerant plants.	The landscape plan incorporates native and drought
Landscaping that does not require	tolerant plants.
permanent irrigation is encouraged.	Drip irrigation is proposed and will provide adequate
	watering during the establishment period.
Landscape buffers should be	Landscape buffers conform to Zoning Bylaw
provided as per Zoning Bylaw.	
Adequate monetary security may be	DP 22-14 requires security of \$709,029 in five
required to ensure that landscaping	installments to ensure landscaping is carried out in
will be completed and established.	accordance with the landscape plan.
Will be completed and established.	A report from a Landscape Architect is required prior to
	release of the required landscape security.
All landscaping should conform to	A landscape plan for the site has been prepared by a
BC Landscape Standard	Landscape Architect to BC Landscape Standards
3	Landscaping is proposed in 6 phases with a landscape     Landscaping is proposed in 6 phases with a landscape
undertaken by a landscape	bond to be collected prior to starting landscape work for
professional during landscape	each phase. Phase 6 works are to be completed prior to
installation.	Phase 5 as specified in the Permit.
13. Energy Conservation and GHG E	
Greater floor to ceiling heights	Ceiling heights have not been increased as suggested by
where possible	the guidelines.
Passive design strategies should be	Buildings are oriented to mitigate sun gain.
used wherever possible.	The location of windows and the floor plan layouts
	maximize natural light and natural ventilation.
	Numerous trees are proposed in the landscape plan
	which will provide some shading to the proposed
	buildings.
Construction waste management	A waste management plan has been prepared and is
plan should be implemented.	attached to DP 22-14.
14. Rain Water Management	
Integrated rain water management.	A stormwater management plan was provided and is
	attached to DP 22-14.
	According to the Stormwater Management memo,
	infiltration will be limited or not practical due to the
	challenging bedrock geology.
Rainwater catchment or green roofs	The proponent is favorable to rainwater barrels, however
are encouraged.	no stormwater capture and re-use systems are proposed.
	Townhouse roof patios provide outdoor space for
	potential vertical and rooftop gardening for residents.
Permeable surfaces should be used.	Permeable surfaces are proposed in the parking areas
	and outdoor amenity spaces.
Minimize asphalt and impervious	and outdoor amenity spaces.
concrete surfacing.  15. Water Conservation	
I I D WATER L ONCERVATION	

Water-saving irrigation systems are encouraged.	The landscape plan specifies an efficient design-build automatic irrigation system with moisture sensors and an	
	automatic rain gauge.	
Innovative wastewater	No wastewater management systems are proposed.	
management systems are		
encouraged.		
16. Recycling, Organics & Solid Waste Management		
Waste and recycling storage should	Waste and recycling storage are located within the	
be inside buildings or integrated into	garages of each townhouse unit.	
site design.	Centralized garbage is provided for each apartment	
	building located in an eclosed area in the underground	
	parking.	
Outdoor enclosures should be	• N/A	
located away from public view and		
screened from overhead views.		
17. Safety		
Visually well-defined areas with	Outdoor amenity areas are located in open and safe	
clear purpose or function and	areas.	
maximizes visibility, light, and	Pathways have adequate lighting proposed.	
openness.		

## DPA 7 - Hazard Lands

Table B. summarizes the analysis of the applicant's proposal against the DPA 7 guidelines.

Table 2: Summary of DPA 7 Hazard Lands guidelines and staff comments.

DPA 7 Guidelines	Staff Comments
A report from a professional engineer should provide technical requirements/mitigation measures for the development.	A geotechnical report from a professional engineer was provided and the proposed development is considered safe provided the recommendations in the report are followed.
Building sites should be designed to minimize the need for significant excavation or filling.	<ul> <li>Buildings are located to minimize disturbance of natural features on the site.</li> <li>Site preparation of the proposed development will include cut and fill operations to facilitate level building and parking areas.</li> <li>Excavation is limited to the immediate development site, specifically for the townhouse buildings 1, 2, and 3, and for apartment buildings 8 and 9. The excavation is reasonable for the proposed development.</li> <li>Significant fill is required for Buildings 4,5,6, and 7 to provide vehicle access, visitor parking, and outdoor amenity area.</li> <li>The building sites are located in a way that minimizes disturbance of natural features on the site.</li> </ul>
Height restrictions may be altered to minimize the need for excavation and fill.	• The applicant has applied for a Development Variance Permit (DVP 24-02) to vary building heights for four of the nine buildings.

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No building or structure shall be constructed in areas subject to bank instability and site development to avoid areas subject to unstable slopes.  Provide for disposal of surface run-off and storm water.	<ul> <li>The location is feasible for construction and the geotechnical report states the gentle to moderately steep slopes can safely accommodate townhouse and multifamily residential buildings.</li> <li>A stormwater management plan has been prepared by civil engineer and evaluated by the geotechnical engineer. The stormwater management plan will include detention systems that meet the project criteria.</li> </ul>
Avoid disturbance to the steep slope.	• The location of buildings minimizes the disturbance of natural features on the site.
Retaining walls to be terraced or stepped to avoid expansive wall surfaces.	<ul> <li>The geotechnical report states landscape walls do not pose slope stability risk to the buildings because they are small enough that deep seated slope stability failures do not occur due to the wall.</li> <li>A 3.23m retaining wall supporting an access lane is proposed along the northwest side of the property north of buildings four and five. A 2m step is proposed which meets the zoning and development permit guidelines.</li> <li>Retaining wall construction shall be reviewed by the Geotechnical or Structural Engineer and is a condition of DP 22-14.</li> </ul>
Existing vegetation should be maintained to control erosion and protect banks. Cleared areas should be replanted to control erosion and protect banks. Security can be taken for landscaping.  Access improvements (stairways, paths)	<ul> <li>As a condition of DP 22-14, best management practices to prevent erosion and sedimentation are to be followed during construction including revegetating exposed soil slopes where existing vegetation has been removed.</li> <li>A landscape bond will be collected in five installments at the beginning each phase of the proposed five-phase development.</li> <li>Additional geotechnical comments stated that</li> </ul>
not to disturb slope or natural slope drainage.	driveway accesses, pedestrian walkways/footpaths, and staircases will require minor manipulation of bedrock or very dense sols which will not affect the stability of the slope.
Development permit may specify sequence and timing to reduce impacts to the environment and surrounding properties.	• The proposed development is to be constructed in 5 phases as described in DP 22-14.



## **MINUTES**

## **Community Planning Advisory Committee**

Wednesday, May 1, 2024 at 7:00 p.m. City Hall Council Chambers, 410 Espanade

**PRESENT:** Chair – Jason Robertson; Members - Keona Wiley, Tonya Soules, Julika Pape, John

Scott; Alt. Council Liaison - Amanda Jacobson; Director of Development Services -

Jake Belobaba; Planner – Julia Tippett; Recorder – Cassandra Taylor

**ABSENT:** Members - Jennifer Aker, Anthony Price; Council Liaison - Marsh Stevens

**GUESTS:** Applicant – Brody Phillips (file no. 3060-24-01)

Chair Jason Robertson called the meeting to order at 7:06pm.

Jason Robertson acknowledged with gratitude that Ladysmith is located on the unceded territories of the Stz'uminus First Nation.

#### 1. ELECTION OF CHAIR

Jason Robertson declared that he will be stepping down as Chair. The Committee has deferred the election of a new Chair to the next meeting.

#### 2. AGENDA APPROVAL

It was moved, seconded, and carried that the Agenda of May 1, 2024, Community Planning Advisory Committee meeting be approved.

#### 3. ADOPTION OF MINUTES

It was moved, seconded, and carried that the Minutes of April 3, 2024, Community Planning Advisory Committee meeting be approved.

#### 4. NEW BUSINES

None

#### 5. COUNCIL REFERRALS

#### a. Development Permit Application 3060-24-01 - 11 & 17 Warren Street

Applicant Brody Phillips introduced himself as the agent acting on behalf of the developer. Brody was available for questions during discussion. Brody noted that the developer is inclined to create affordable housing within the Town of Ladysmith.

Planner Julia Tippett provided an overview of the Development Permit application at 11 & 17 Warren Street for the purpose of obtaining feedback from CPAC on the application as it pertains to the DPA 2.

During discussion, Committee members raised questions regarding the exterior design of the proposal, snow storage and drainage, retention and planting of shade

trees, parking, and waste management. The applicant is prepared to take these questions back to the designer for further discussion.

Committee members felt that overall, the application aligns well with the look and feel of downtown and were particularly pleased with the articulation of the roof line. The Committee has no major concerns with the proposal.

It was moved, seconded, and carried that the Community Planning Advisory Committee recommends that Council approve Development Permit application 3060-24-01 for 11 & 17 Warren Street as presented subject to the following comments:

- That Council consider the following pertaining to the DPA 2 Downtown guidelines:
  - The form and character on the north-east lane side on the property;
  - Storm water management;
  - Retention of shade trees;
  - Snow storage; and
  - Onsite homeowner/tenant storage to help maintain the form and character of the downtown area.

#### 6. MONTHLY BRIEFING

- 3360-22-07 District Proposal (Lot A Holland Creek) going to council on May 7 for introduction.
- Director of Development Services Jake Belobaba provided a brief update on the Provincial Small Scale Multi-Unit Housing legislation. Staff have been working towards the June 30 deadline.

#### 7. NEXT MEETING – TBD

#### 8. ADJOURNMENT

It was moved, seconded, and carried that the meeting be adjourned at 8:06 PM.

	Chair (Jason Robertson)
RECEIVED:	
	_
Corporate Officer (S. Bouma)	

## Committee of the Whole Recommendations to Council May 21, 2024

At its May 14, 2024 meeting, the Committee of the Whole recommended:

#### 1. That Council:

- a) Give first, second and third readings to "Town of Ladysmith Animal Control Bylaw 2024, 2167"; and
- b) Direct staff to bring forward consequential amendments to the "Town of Ladysmith Zoning Bylaw 2014, No. 1860".

#### 2. That Council direct staff to:

- a) Amend "Town of Ladysmith Community Centre Facilities Fees and Charges Bylaw 2021, No. 2086," as presented in Attachment A of the May 14, 2024, staff report;
- b) Present the proposed FJCC admission changes to the Cowichan North Recreation Commission and Cowichan Valley Regional District for their respective endorsement;
- c) Upon the Commission's and Board's endorsement, bring the amended "Community Centre Facilities Fees and Charges Bylaw 2021, No. 2086" to Town of Ladysmith Council for consideration; and
- d) Amend the "Fees and Charges Department: Parks, Recreation and Culture Policy" definition of family from four to six children.









# COMMITTEE OF THE WHOLE MEETING MINUTES

Tuesday, May 14, 2024 6:13 P.M. Ladysmith Seniors Centre 630 2nd Avenue

#### **Council Members Present:**

Councillor Tricia McKay, Chair Mayor Aaron Stone Councillor Ray Gourlay Councillor Amanda Jacobson Councillor Duck Paterson Councillor Marsh Stevens Councillor Jeff Virtanen

#### **Staff Present:**

Allison McCarrick Chris Geiger
Erin Anderson Michele Gill
Chris Barfoot Maggie Robinson

Jake Belobaba Sue Bouma
Ryan Bouma Andrea Hainrich

#### 1. CALL TO ORDER AND ACKNOWLEDGEMENT

Councillor McKay, Chair, called this Committee of the Whole meeting to order at 6:13 p.m., and acknowledged with gratitude that it was being held on the unceded territory of the Stz'uminus First Nation.

#### 2. AGENDA APPROVAL

#### CW 2024-025

That the agenda for this May 14, 2024 Committee of the Whole meeting be approved.

**Motion Carried** 

#### 3. MINUTES

## 3.1 Minutes of the Committee of the Whole Meeting held March 12, 2024

#### CW 2024-026

That the minutes of the Committee of the Whole Meeting held March 12, 2024 be approved.

Motion Carried

#### 4. PRESENTATION

## 4.1 Geographic Information System (GIS) DEMONSTRATION

Engineering staff, Michele Gill and Maggie Robinson, presented the new GIS mapping system, and demonstrated the functions of the internal and external tools to Council. They also discussed next steps, such as including street lighting, asbestos piping, garbage and plow routes, and active building permits in town.

Chair McKay thanked staff for their presentation and for bringing this technology forward.

#### 5. DISCUSSSION

## 5.1 Ladysmith Detachment Annual Policing Priorities for 2024 to 2025

Council discussed policing priorities for 2024-2025. Their list included the need for increased visibility in key areas of speeding, (school zones, playgrounds, parks, and main corridor roads), increased visibility around the overnight shelter, and greater consistency and longevity in leadership for the detachment.

The RCMP will return to a future Committee of the Whole or Council meeting to speak on these items and add insight to areas of concern from the RCMP point of view.

#### 6. REPORTS

## 6.1 Building Inspector's Report to April 30, 2024

#### CW 2024-027

That the Committee receive the Building Inspector's Report for the months January to April 2024.

**Motion Carried** 

## 6.2 Ladysmith Fire/Rescue Reports for March and April 2024

#### CW 2024-028

That the Committee receive the Ladysmith Fire/Rescue Reports for the months March and April 2024.

Motion Carried

## 6.3 Coastal Animal Control Services Reports for January to March 2024

#### CW 2024-029

That the Committee receive the Coastal Animal Control Services Reports for the months January to March 2024.

Motion Carried

## 6.4 2024 Q1 (Jan-Mar) Financial Update

#### CW 2024-030

That the Committee receive the staff report dated May 14, 2024, regarding the 2024 Q1 (Jan to March) Financial Update from the Director of Financial Services.

Motion Carried

### 6.5 2023-2026 Strategic Priorities Update

#### CW 2024-031

That the Committee receive the 2023-2026 Strategic Priorities Update dated May 14, 2024.

Motion Carried

## 6.6 Proposed Animal Control Bylaw to allow Backyard Poultry and Goats for Vegetation Management

#### CW 2024-032

That the Committee recommend that Council:

- 1. Give first, second and third readings to "Town of Ladysmith Animal Control Bylaw 2024, 2167".
- 2. Direct staff to bring forward consequential amendments to the "Town of Ladysmith Zoning Bylaw 2014, No. 1860".

#### CW 2024-033

**AMENDMENT** 

That the Committee recommend that Bylaw 2167 be separated into two bylaws, with one addressing backyard poultry and the other addressing vegetation management.

Amendment Defeated

OPPOSED: Mayor Stone, Councillors Paterson, Stevens, and McKay.

#### CW 2024-032

The question was called on the main motion as presented.

Motion Carried

OPPOSED: Councillors Virtanen and Paterson

### 6.7 PRC Fees and Charges Proposed Changes and Amendments

#### CW 2024-034

That the Committee recommend that Council direct staff to:

- Amend "Town of Ladysmith Community Centre Facilities Fees and Charges Bylaw 2021, No. 2086," as presented in Attachment A of the May 14, 2024, staff report;
- Present the proposed FJCC admission changes to the Cowichan North Recreation Commission and Cowichan Valley Regional District for their respective endorsement;
- Upon the Commission's and Board's endorsement, bring the amended "Community Centre Facilities Fees and Charges Bylaw 2021, No. 2086" to Town of Ladysmith Council for consideration; and
- 4. Amend the "Fees and Charges Department: Parks, Recreation and Culture Policy" definition of family from four to six children.

**Motion Carried** 

#### 7. COUNCIL SUBMISSIONS

## 7.1 Council Meeting Venue Change

Council discussed the possibility of holding a Council meeting or Committee of the Whole meeting at Ladysmith Secondary School, to encourage civic engagement with youth in the Town. Councillor Paterson will meet with the principal and follow up with Council.

## 8. ADJOURNMENT

CW 2024-03	35
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That this Committee of the Whole Meeting be adjourned at 7:27 p.m. *Motion Carried* 

	CERTIFIED CORRECT
Chair (Councillor T. McKay)	Corporate Officer (S. Bouma)

## **TOWN OF LADYSMITH**

## BYLAW STATUS SHEET May 21, 2024

Bylaw #	Description	Status
2131	"Town of Ladysmith Zoning Bylaw 2014, No. 1860, Amendment Bylaw (No. 54) 2022, No. 2131" (10940 Westdowne Rd.). Changes zoning from Rural Residential (RU-1) to Manufactured Home Park (MHP-1).	First and second readings, December 20, 2022. Public Hearing and third reading December 19, 2023. MOTI approval received January 15, 2024. Awaiting covenant.
2133	"Town of Ladysmith Zoning Bylaw 2014, No. 1860, Amendment Bylaw (No. 56) 2023, No. 2133". Allows convenience store at 1132-1142 Rocky Creek Rd.	First and second readings, January 10, 2023. Public Hearing required. MOTI approval required. Waiting on applicant to submit Development Permit per Council Resolution
2161	"Official Community Plan Bylaw 2022, No. 2200, Amendment Bylaw 2023, No. 2161". To expand the mobile home park at 10940 Westdowne Road.	First and second readings, November 21, 2023. Second reading rescinded, second reading as amended, December 5, 2023. Public Hearing and third reading December 19, 2023. Awaiting covenant.
2166	"Town of Ladysmith City Hall Loan Authorization Bylaw 2024, No. 2166". To enable the Town to borrow up to \$13.5 million dollars over a term of 30 years to fund the construction of a new City Hall.	First, second and third readings, January 23, 2024. Inspector of Municipalities approval received February 26, 2024. Approval of the electors required through an Alternative Approval Process.
2170	"Official Community Plan Bylaw 2003, No. 1488, Amendment Bylaw 2024, No. 2170". (To reallocate units for a portion of the Holland Creek neighbourhood to create a smaller development footprint, eliminate the need for a crossing over Heart Creek and adjust triggers for infrastructure construction).	First and second readings, May 7, 2024. Public Hearing scheduled May 21, 2024.
2171	"Town of Ladysmith Zoning Bylaw 2014, No. 1860, Amendment Bylaw 2024, No. 2171". (To reallocate units for a portion of the Holland Creek neighbourhood to create a smaller development footprint, eliminate the need for a crossing over Heart Creek and adjust triggers for infrastructure construction).	First and second readings, May 7, 2024. Public Hearing scheduled May 21, 2024. Moti approval required.



## AGENDA FOR NATIONAL INDIGNEOUS PEOPLE'S DAY FRIDAY, JUNE 21, 2023 10 AM-3 PM

## Transfer Beach Park & Amphitheatre – Ladysmith, BC

#### **Location: Amphitheatre**

10:00 am Welcome & Opening Remarks – Chief John Elliott & Mayor Aaron Stone

#### MC Event - Ray Harris & Chief John Elliott

10:10 am	Hul'q'umi'num' Opening Prayer - by Beverly 'Buffi' David
10:15 am	Stz'uminus Anthem – by Buffi David & Stz'uminus Community
10:20 am	Giving Back to the Communities – Kwumut Lelum Foundation
10:30 am	Special Guest Speaker(s)
11:00 am	Tzinqwa Song/Dance Group, Friendship Dance – Andrew Peters – Quw'utsun *
11:40 am	Music Entertainment for the Youth

#### **Location: Main Field**

<b>12:00 pm</b> Prayer for Food by Elder Buffi	David
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- BBQ by SFN Leadership & Town Council
- Lunch served at the Hut by SFN Administration Staff
- Elders served by SFN Health staff
- **1:00 pm** Music Entertainment, Bouncy Castles, Interactive Games, Wellness Tent, Kids Activities, Stz'uminus Artist Vendor Tables, Information Booths.
- 3:00 pm Closing Remarks
- 3:30 pm Clean-up

## ARTS – CULTURE – ENTERTAINMENT